1	HONORABLE RICARDO S. MARTINEZ
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7	UNITED STATES DISTRICT COURT
8	WESTERN DISTRICT OF WASHINGTON AT SEATTLE
9	PUGET SOUNDKEEPER ALLIANCE,)
10) Case No. 12-01201RSM Plaintiff,
11	v. AMENDMENT TO CONSENT DECREE
12	SEATTLE IRON & METALS, CORP.,)
13	Defendant.
14)
15	
16	I. RECITALS
17	A. On March 15, 2019, this Court entered a consent decree in this matter (Dkt. #84)
18	(the "Consent Decree") by which Plaintiff Puget Soundkeeper Alliance ("Soundkeeper") and
19	defendant Seattle Iron & Metals Corporation ("SIMC") resolved all claims that Soundkeeper had
20	asserted in its Complaint (Dkt. #1) and Amended Complaint (Dkt. #4).
21	B. Soundkeeper and SIMC desire to amend the Consent Decree as provided by Section
22	15 of the Consent Decree.
23	C. Soundkeeper and SIMC, therefore, stipulate to the entry of this Amendment to
24	Consent Decree without trial, adjudication, or admission of any additional issues of fact or law.
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II. AMENDMENT TO CONSENT DECREE

The Consent Decree is amended as follows:

- 1. Section 7(b) of the Consent Decree is amended and replaced as follows:
 - b. 730 Facility Paving and Engineering Report and Implementation
 - i. SIMC will conduct monthly stormwater discharge monitoring for the parameters identified in Table 1 of Administrative Order No. 13739 (Dkt. 42-23) (including PCB testing by EPA method 8082) for three years (through February 2022), except that SIMC may cease monthly monitoring for any non-PCB parameter that is not detected for twelve consecutive months of sampling.
 - ii. SIMC will maintain the chitosan-enhanced sand filtration
 (CESF) system that was installed to replace the modular wetland treatment
 system on July 12, 2020.
- 2. Section 7(e) of the Consent Decree is amended and replaced as follows:
 - e. Deduster.
 - i. SIMC has completed design drawings for the shredder enclosure, blower, and dust collection system (hereinafter "deduster") that meet the requirements of this section and are approved by Dr. Ranajit Sahu, the parties' joint consultant. SIMC has submitted applications for the permits that are necessary to install the deduster. (Application materials are included herein as **Attachment A**.) The deduster will address the dust from the shredding process itself and will create sufficient containment to allow a blower to create sufficient negative pressure within it to maximize the capture of dust emissions from the shredder, to the satisfaction of Dr. Sahu.
 - ii. SIMC will exercise its best efforts to obtain all necessary permits for construction and installation of the deduster as soon as

practicable, including but not limited to promptly responding to any City of Seattle requests for corrections to the deduster permit application materials.

iii. Within 63 weeks of the City of Seattle's issuance of the building and land use permit(s) (including, but not limited to, a shoreline substantial development permit) for the deduster, SIMC shall complete installation of the permitted deduster and put the deduster into full operation. In the event that SIMC fails to complete installation of the deduster and put the deduster into full operation within 63 weeks of permit issuance, SIMC shall pay stipulated penalties of \$1,000 per day for each day in which it violates the deadline established in this paragraph. SIMC shall pay these stipulated penalties directly to Just Health Action via payment by check to address provided in **Attachment B**. Payment must be made within 30 days of violating the deadline. In the event that SIMC violates the deadline for more than 1 day, payments may be consolidated into monthly checks paid no later than every 30 days until SIMC comes into compliance with this section.

iv. After the deduster is installed and operational, SIMC shall not operate its auto shredder unless all components of the deduster are fully intact and fully functional, and the blower, and dust capture system are fully functional and properly maintained. In addition, from May 1, 2021 until the deduster is installed and fully operational, SIMC shall not operate its auto shredder on the following days:

- Saturday afternoons (from 12:00 PM to 12:00 AM) during the dry season (May 1 to September 30);
- Sundays during the dry season (May 1 to September 30);
- Memorial Day;

- Independence Day; and
- Labor Day.
- 3. Section 7(f) of the Consent Decree is amended and replaced as follows:
 - f. Wind fences and trommel enclosure.
 - i. SIMC has completed design drawings and City of Seattle permit applications for wind fences and a trommel enclosure that meet the requirements of this section and are approved by Dr. Ranajit Sahu, the parties' joint consultant. SIMC has submitted applications for the permits that are necessary to install the wind fences and trommel enclosure, and those applications are currently pending. (Application materials are included herein in **Attachments A and C**).
 - ii. SIMC will exercise its best efforts to obtain all necessary permits for construction and installation of the wind fences and trommel enclosure as soon as practicable, including but not limited to promptly responding to any City of Seattle requests for corrections to the permit application materials.
 - iii. Within 23 weeks of the City of Seattle's issuance of the building and land use permit(s) (including, but not limited to, a shoreline substantial development permit) for the wind fences, SIMC will install the permitted wind fences. In the event that SIMC fails to install the wind fences within 23 weeks of permit issuance, SIMC shall pay stipulated penalties of \$1,000 per day until the wind fences are installed. SIMC shall pay these stipulated penalties directly to Just Health Action via payment by check to address provided in Attachment B. Payment must be made within 30 days of violating the deadline. In the event that SIMC violates deadline for more than 1 day, payments may be consolidated into monthly checks paid no later than

every 30 days until SIMC comes into compliance with this section.

- iv. Within 21 weeks of the City of Seattle's issuance of the building permit for the trommel enclosure, SIMC shall install the permitted trommel enclosure. In the event that SIMC fails to install the trommel enclosure within 21 weeks of permit issuance, SIMC shall pay stipulated penalties of \$1,000 per day until the trommel enclosure is installed. SIMC shall pay these stipulated penalties directly to Just Health Action via payment by check to address provided in Attachment B. Payment must be made within 30 days of violating the deadline. In the event that SIMC violates deadline for more than 1 day, payments may be consolidated into monthly checks paid no later than every 30 days until SIMC comes into compliance with this section.
- 4. Section 7(g) of the Consent Decree is amended and replaced as follows:
 - g. Dust emissions monitoring and corrective action.

Under the direction of Dr. Sahu and with Soundkeeper's full involvement, SIMC will design and implement the following three-phase dust monitoring regime:

- i. Phase I: In 2019, SIM conducted ten weeks of "background" dust monitoring at no fewer than three monitoring stations offsite, with the locations selected by Dr. Sahu. A meteorological station was maintained during the study period at the same location as in Dr. Sahu's 2018 study. Each monitoring station monitored total suspended particulate ("TSP") and PM 2.5 on a continuous basis, and also collect TSP for the duration. The collected TSP was analyzed for PCBs using Method 1668, metals, and dioxins.
- ii. Phase II: Starting in June of 2020, SIMC will conduct one year of continuous dust monitoring at the following locations (1) the same

two locations as in Dr. Sahu's 2018 study; and (2) at least three additional locations selected by Dr. Sahu on the north, south and east fence lines of SIM's 701 Myrtle parcel. This phase is intended to document SIMC's dust emissions prior to installation of the dust management BMPs required by Sections 7(e) and 7(f) of this Consent Decree. Each monitoring station will monitor TSP and PM 2.5 on a continuous basis and will also collect TSP for the duration. As detailed in the June 2020 Dust Monitoring Plan: Phase II, from the beginning of the Phase II monitoring through at least September 11, 2020, SIMC shall collect TSP weekly and cause it to be analyzed for PCBs using Method 1668, metals, and dioxins monthly. From September 12, 2020 through the end of the Phase II monitoring (June 15, 2021), SIMC shall composite the media and filters collected during each approximately 3month sampling period for analysis, resulting in a total of three PCB and dioxin results at each location, one each for the sampling periods September 15 – December 15, 2020, December 15, 2020 – March 15, 2021, and March 15 – June 15, 2021. If there is an insufficient volume of dust in any sample to complete the foregoing analyses, Soundkeeper will determine the parameters to be analyzed.

iii. Phase III: Upon installation of all of the dust control equipment referenced in Paragraphs 7(e) and 7(f), above, SIMC will commence two years of continuous dust monitoring at the same locations monitored in Phase II. Each monitoring station will monitor TSP and PM 2.5 on a continuous basis, and will also collect TSP for the duration. SIMC shall collect the TSP and cause the collected TSP to be analyzed for PCBs using Method 1668, metals, and dioxins, as specified above for the Phase II monitoring or as otherwise directed by Dr. Sahu. This phase is intended to

document SIMC's dust emissions following installation of dust management BMPs required by Sections 7(e) and 7(f) of this Consent Decree.

- iv. Correspondence: Soundkeeper and SIMC will be copied on all correspondence to and from Dr. Sahu by the other regarding dust analysis or the design of dust control measures or studies. Soundkeeper and SIMC will be notified of and permitted to participate in any substantive meetings or conference calls with Dr. Sahu relating to the dust analysis or the design of dust control measures or studies. All data from the dust monitoring studies described in this Consent Decree will be shared with Soundkeeper within seven days of it becoming available to SIMC.
- Website: SIMC agrees to maintain the public facing webpage v. (www.seairon.com/environmental-documents) and to post all data collected during each of the three phases described above within 14 days of data validation. SIMC will post copies of all final reports produced by Dr. Sahu to analyze the data on this webpage within 7 days of report finalization. SIMC will also fund production by Dr. Sahu of publicly accessible explanations and summaries using nontechnical language, and depicting data both numerically and graphically, to post on webpage contemporaneously. SIMC also agrees to fund the translation of the reports and summaries into Spanish and Vietnamese, and to post the translated copies on the above-mentioned webpage within 7 days of translation. SIMC will pay translation costs directly to mutually acceptable translators within 14 days of invoicing.
- vi. Public Meetings: SIMC agrees to coordinate with Soundkeeper on community town hall meetings to occur annually for the duration of the Consent Decree in either Georgetown or South Park to

publicize results of each phase of the dust study, and answer community questions and concerns. SIMC agrees to have at least one facility representative present at each meeting, and also agrees to fund Dr. Sahu's attendance and presentation. SIMC further agrees to fund the costs of the meeting space, language translation (Spanish and Vietnamese), production and printing of outreach materials, dinner for attendees, and onsite childcare for attendees. SIMC will pay all costs directly to mutually agreeable vendors.

vii. Corrective action: The data from the first dry season of the Phase III dust monitoring described above must be analyzed to determine if the controls are effective. If the controls are not effective at reducing the dust concentrations during SIMC's operating hours (during dry weather) to $10~\mu g/m^3$, or the background level determined by Dr. Sahu based on additional data collection, and reducing PCBs to the background PCB levels determined in Phase I monitoring completed under Section 7(g)(i) of this Consent Decree (hereinafter, the "Phase I background PCB level"), SIMC must commit to enhancing the controls as follows:

1. If the dust controls installed at the 601 Myrtle parcel of the 601 Facility, or the 701 parcel of the 601 Facility, as measured during Phase III, are insufficient to reduce the dust concentrations during SIM's operating hours (during dry weather) to $10 \,\mu\text{g/m}^3$, or the background level determined by Dr. Sahu based on additional data collection, or the PCBs are above the Phase I background PCB levels, Dr. Sahu will inspect the pertinent facility and make recommendations for appropriate improvements to address the issues. Within two months of such

an inspection, Dr. Sahu will issue his recommendations. SIMC must implement Dr. Sahu's recommendations before the onset of the next dry season. If SIMC determines that one or more of the recommendations are not practicable or implementable then SIMC may invoke the dispute resolution provisions of this Consent Decree and obtain relief from Dr. Sahu's recommendations from the Court in the form of a modification to this Consent Decree.

viii. SIMC will pay into Smith & Lowney PLLC's client trust account money sufficient to cover the cost of Dr. Sahu's work under this Consent Decree. Smith & Lowney PLLC will administer the funds to Dr. Sahu, but SIMC is solely responsible for adequately funding the trust account to cover the cost of Dr. Sahu's work and any subcontractors and laboratory costs.

ix. SIMC will continue to maintain daily logs of dust observations and dust control efforts at the 601 Facility during the period May 1 through September 30 each year, and during extended dry periods (defined by the absence of rainfall for more than five days) during the period October 1 through April 30. Not later than the date of entry of this Consent Decree, SIMC will begin keeping track of whether its auto shredder is operating normally and any unusual shredding activities with the potential to generate dust on the daily logs. Log entries shall be made for all hours during which the Facility and/or the shredder operates.

x. Not later than the date of entry of this Consent Decree, SIMC will implement a program to discourage truck traffic associated with the Facilities from using certain residential streets nearby the Facilities.

Specifically, SIMC will post the Approved and Restricted Traffic Routes map and legend, attached to this Amendment to Consent Decree as **Attachment D**, to its website, and provide copies of the map to and instruct trucks entering and exiting the Facilities to use the Approved Routes and avoid the Restricted Routes identified in Attachment D.

- xi. SIMC will arrange a meeting with Soundkeeper, the City of Seattle, and Ecology to discuss the Filterra treatment systems in the city right-of-way abutting the north and south sides of the 601 Facility and will employ its best efforts to coordinate with the City of Seattle and Ecology regarding this issue.
- 5. Section 7(h) of the Consent Decree is amended and replaced as follows:
 - h. Starting on March 15, 2019, and continuing for six years, SIMC will forward all correspondence to and from the Department of Ecology, and all documents provided to the Department of Ecology, related to the NPDES Permits, and monthly dust control logs and dust observation or complaint emails SIMC receives in the corresponding month, to Soundkeeper on a monthly basis, and provide written summaries to Soundkeeper on its progress implementing the consent decree, on a quarterly basis. Where practicable, as in the case of structural improvements, SIMC will include photographs of tasks completed in its quarterly progress reports to Soundkeeper. SIMC will also provide Soundkeeper with electronic copies of its SWPPPs as required herein and upon request within 5 days.
- 6. Section 7(i) of the Consent Decree is amended and replaced as follows:
 - i. Not later than thirty days after invoicing, SIMC will pay Soundkeeper its reasonable costs, including expert and attorneys' fees, of monitoring SIMC's compliance with this consent decree, and conferring regarding corrective actions and dispute resolution pursuant to this consent decree, in an

amount not to exceed \$60,000 (SIXTY THOUSAND DOLLARS).

- 7. Section 8 of the Consent Decree is amended and replaced as follows:
- 8. Not later than thirty days after entry of this Amendment to Consent Decree, SIMC will pay \$90,000 (NINETY THOUSAND DOLLARS) to Just Health Action and Seattle Parks Foundation via payments of \$45,000 to each organization by check to addresses provided in **Attachments B and E** for environmental and human health benefit projects in the Duwamish River and central Puget Sound watersheds as described in Attachments B and E. Payment shall include the following reference in a cover letter or on the check: "Amendment to Consent Decree, Soundkeeper v. Seattle Iron & Metals Corps." A copy of the check and cover letter shall be sent simultaneously to Soundkeeper. Additionally, in the event that SIMC fails to install the deduster by the deadline established in Section 7(e)(iii), above, SIMC will pay an additional \$10,000 to Just Health Action. In the event that SIMC further fails to install the deduster within 60 days of the deadline established in Section 7(e)(iii), above, SIMC will pay an additional \$15,000 to Just Health Action. These contingent payments are in addition to any stipulated penalties required by Section 7(e)(iii), above.
- 8. Section 13 of the Consent Decree is amended and replaced as follows:
- 13. This Consent Decree takes effect upon entry by the Court. It terminates on March 15, 2026.
- 9. The contact information for SIMC in Section 17 of the Consent Decree is amended as follows:

1	if to Seattle Iron & Metals Corp.:
2	Matthew Stock
3	JOYCE ZIKER PARTNERS, PLLC 1601 Fifth Avenue, Suite 2040
4	Seattle, WA 98101
5	Email: mstock@jzplaw.com
6	10. Except as specifically amended by this Amendment to Consent Decree, the terms
7	and conditions of the Consent Decree (Dkt. #84) remain in full force and effect.
8	
9	DATED this 30 th day of October, 2020.
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2	RICARDO S. MARTINEZ
3	CHIEF UNITED STATES DISTRICT JUDGE
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$\begin{bmatrix} \\ 8 \end{bmatrix}$	
	Presented by:
$\begin{bmatrix} 0 & 1 \\ 0 & 1 \end{bmatrix}$	JOYCE ZIKER PARTNERS, PLLC SMITH & LOWNEY PLLC
1	
2	By: <u>/s/ Matthew Stock</u> By: <u>/s/Claire E. Tonry</u>
	Matthew J. Stock, WSBA No. 40223 Richard A. Smith, WSBA No. 21788 Attorneys for Defendant SIMC Claire E. Tonry, WSBA No. 44497
3	Attorneys for Plaintiff Soundkeeper
4	
5	
6	

Attachment A

City of Seattle
Department of Construction and Inspections (Seattle DCI)
PLAN COVERSHEET
Updated
01/01/16

INSTRUCTIONS: Complete all areas of sections 1 - 7 that pertain to your project. Please note that sections 8 - 14 are to be completed by Seattle DCI staff.

*Mac users fill out this form with Acrobat not Reader

1. APPLICANT INFORMATION	5. BUILDING CODE INFORMATION	8. LAND USE CONDITIONS (Seattle DCI staff use only)	10. DRAINAGE & SEWER REVIEW (Seattle DCI staff use only)	
	MULTIPLE BUILDINGS IN THIS PROJECT? Yes No	Assigned planner Phone	SEATTLE DCI SEWER AND DRAINAGE REVIEW DESK: (206) 684-5362 or sidesewerinfo@seattle.gov	
PROJECT ADDRESS PROJECT #	If yes, fill out separate sheets and attach. Shown on plan sheet:	7 congress planted	DRAINAGE REVIEW REQUIRED? Yes No	
DESCRIPTION OF WORK	PROVIDE THIS INFORMATION FOR EVERY BUILDING IN YOUR PROJECT		Flow control required	
	DCI building ID (see building data sheet)		Impervious surface this project (new or replaced) in sq. ft.	
	Existing # of above-grade stories		Impervious surface this project (new or replaced) in sq. it.	
	Existing # of below-grade stories			
OWNER ADDRESS			NOTE: The drainage system shown in these plans may be changed at the time of side sewer permit issuance to meet standard plans and method	
PHONE E-MAIL	Building code type of construction		SIDE SEWER REVIEW REQUIRED? Yes No	
CONTACT PERSON ADDRESS	FLOOR LEVEL GROUP OCCUPANCY/USE FLOOR AREA SPRINKLER (Y/N) OTHER FIRE PROTECTION			
CONTACT PERSON ADDRESS			No conflict with side sewer Construction conflicts with applicant's side sewer. Contact Public Health Department at (206) 233-7914	
PHONE FAX E-MAIL			Construction conflicts with side sewer serving another property . Contact Seattle DCI Sewer and Drainage Review Desk at (206) 684-5362	
PREVIOUS RELATED MUPs				
RELATED STANDARD PLANS			Reviewed by Date	
			NOTE: A consent side course growth is acquired from Coattle POLifer ALL your desirance and course installations. For your information, call the	
2 LAND LICE CODE INFORMATION	Remodel: Construction project value \$		NOTE: A separate side sewer permit is required from Seattle DCI for ALL new drainage and sewer installations. For more information, call the Sewer and Drainage Review Desk at (206) 684-5362 or sidesewerinfo@seattle.gov.	
2. LAND USE CODE INFORMATION	Sprinklers NFPA 13 NFPA 13 Partial system Tire alarm Other system Type			
ZONE DESIGN REVIEW? Yes No	Change of occupancy Yes No From To		11. ENVIRONMENTALLY CRITICAL AREAS INFO (Seattle DCI staff use only)	
ZONE ASSESSOR'S PARCEL NO. If yes, please provide:	Posted occupancy		ENVIRONMENTALLY CRITICAL AREAS (ECA)	
OVERLAY ZONING Planner	EMERGENCY SYSTEMS PROVIDED Elevator pressurization Exit and pathway lighting Stairway pressurization Smoke removal system Emergency generator		Site is not located in ECA	
HISTORIC OR LANDMARK DISTRICT	Literator pressurization Literatural lighting Starway pressurization Sinoke removal system Little generator		Mapped ECA designation	
Planner's phone no.			ECA identified by pre-application site visit report as	
SHORELINE ZONE Evernet Pequires Shoreline routions	6. ENERGY/MECHANICAL CODE		ECA exemption (see review details in Hansen)	
Exempt Requires Shoreline review Exempt Requires review	HVAC mechanical system is NOT included with this application (If mechanical drawings are included with plans, please stamp "for reference only")		Reviewed by Date	
SEPA LXeITIPL Requires review	HVAC mechanical system IS included with this application Mechanical System Value\$			
EXISTING USE SQ. FT. PROPOSED USE SQ. FT.	GENERAL PROJECT INFORMATION		Denied Granted Type	
	SCOPE OF CONSTRUCTION		Small project waiver	
	New construction Addition Substantial alteration (SBC CH 34)		New development coverage this permit (sq. ft.)	
			Previous development coverage (after 10/31/92) Permit # Sq. ft.	
	APPLICABLE OCCUPANCY		Permit # Sq. ft.	
	Single-family/duplex/townhouse		Sq. it.	
DEPARTMENT OF NEIGHBORHOODS CERTIFICATE OF APPROVAL REQUIRED?	BUILDING ENVELOPE COMPLIANCE HEATED SEMI-HEATED UNHEATED		Total	
STREET/ALLEY IMPROVEMENTS OR WORK IN THE RIGHT OF WAY REQUIRED?	Existing Envelope - no change			
PARKING SPACES NUMBER OF DWELLING UNITS	Existing Envelope - altered	NEW CURB CUT REQUIRED Yes No Residential Commercial	12. SHOP DRAWINGS, KEY AREA INSPECTION & BUILDING CONDITIONS	
Existing Onsite Offsite Accessible Existing Proposed New	New Envelope		(Seattle DCI staff use only)	
Proposed Onsite Offsite Accessible Demolished Live/Work	SCOPE OF MECHANICAL WORK	9. SPECIAL INSPECTIONS (Seattle DCI staff use only)		
Offsite Location TOTAL		or or zon	Sprinkler drawings	
			Required shop drawings/	
3. HOUSING UNIT OCCUPANCY	LOCATION OF DUCTWORK OF MECHANICAL FOLIRMENT		key area inspections:	
DEFINITION: Housing unit means any dwelling unit, housekeeping unit, guest room, dormitory, or single room occupancy unit, and may include a residential	LOCATION OF DUCTWORK OR MECHANICAL EQUIPMENT			
unit in a commercial building, an artist's studio dwelling unit, or a live/work unit.	☐ Interior ☐ Exterior ground mounted ☐ Rooftop ☐ Exterior wall mounted MECHANICAL-ONLY PERMIT ☐ Exterior wall mounted			
CHECK ONLY ONE BOX BELOW TO INDICATE HOUSING OCCUPANCY AT DATE OF PERMIT APPLICATION.	Related building permit project #		13. PERMIT ISSUANCE AUTHORIZATION	
Unit(s) unoccupied Unit(s) occupied by residential tenant	COMMERCIAL BUILDINGS (Non-residential, R1 lodging, and Multi-family four stories and greater)		(Seattle DCI staff use only)	
☐ Unit occupied by property owner ☐ Do not know ☐ No units on property ☐ Refer to property owner/tenant assistance	COMPLIANCE PATH:			
Unit(s) on property not affected by permit scope	Prescriptive Component Performance UA/SHGCA/VTA Total building performance (TBP) Target performance path (TPP)		REVIEW APPROVAL DATE NOTES LOCATION INITIALS	
	SEC C402.1 SEC C402.1.3 SEC C402.1.5		ZONING (incl. street improvements)	
I certify, under penalty of perjury under the laws of the State of Washington, that the above information is true and correct.	OTHER MECHANICAL EQUIPMENT INCLUDED IN THIS APPLICATION		CURB CUT	
	Commercial kitchen hood exhaust system Fume hood Spray paint booth Other Specify:		ORDINANCE	
Owner/Applicant Signature Printed Name Date Place	RESIDENTIAL BUILDINGS (Single family, duplex, townhouse, and multi-family 3 stories or less) COMPLIANCE PATH:		STRUCTURAL	
			ENERGY	
4. GROUND DISTURBANCE	Prescriptive Total UA alternative Simulated performance alternative Heating Equipment:		MECHANICAL DRAINAGE	
	Minimum Size: Energy Credit (Table R406.2) Option:		ECA E	
GROUND DISTURBANCE Yes No Excavation - cubic yards Maximum height	DOCUMENTS INCLUDED		GRADING GRADING	
Fill - cubic yards Maximum height DISPOSAL SITE Qutside City of Seattle			WATER (SPU)	
Outside Oity of Seattle	Residential equipment sizing calc (unit by unit) Non-residential cooling and heating load (for other than Group R) Target UA/SHGCA/VTA Calculation Structural load calculation (for mechanical equipment) Commercial kitchen hood worksheet		FIRE	
Inside City of Seattle Address and/or permit #	TBP or TPP Report Noise compliance report (for mechanical equipment) Other:		HEALTH (King County)	
Erosion control is required PRIOR to any ground disturbance. Please refer to Construction Stormwater Control and Soil Amendment Standard Plan.			NOISE	
CUSTOMER ALERT!	7. PRIORITY GREEN		CONVEYANCE/ELEVATOR SHORING (SDOT)	
Site Inspection Required Prior to First Ground Disturbance - Call (206) 684-8900	(www.seattle.gov/sdci/prioritygreen)		STREET IMPROVEMENT (SDOT)	
A Seattle DCI site inspection is required prior to any ground disturbance related to this permit, including clearing, grubbing or grading. Preconstruction Conferences, When Required - Call (206) 684-8860	Prior approval to participate in Priority Green is required. The following does not establish Priority Green status.		PARKS	
A Seattle DCI preconstruction conference should be scheduled prior to beginning work. A conference is required for the following types of work: 1. When any special inspections are indicated on the plan	PRIORTY GREEN EXPEDITED PRIORTY GREEN FACILITATED		PROTECTED DISTRICTS (DON)	
2. When land use or design review conditions are indicated on the plan 3. When a Seattle DCI plans examiner specifies on plans unusual or complex inspection or occupancy requirements	Screening required prior to building permit intake appointment. Screening required prior to building permit or MUP intake appointment.		SEPA EXEMPTION	
Rules for Ufer Grounds - Call (206) 684-5383	Rating anticipated: Rating anticipated:		LAND USE	
If you have any questions or concerns regarding the rules (2005 NEC) for installation of ufer grounds, please contact Seattle DCI's Electrical Technical Backup Monday - Friday, 7:00 a.m. to 4:30 p.m.	Built Green Priority Green Building Matrix - 10 points			
Required SDOT Permits and Inspections	4 star		14. DEPARTMENT SIGN OFFS (Seattle DCI staff use only)	
Street Tree Inspections Protection and/or planting/pruning/removal of street trees requires Seattle Department of Transportation (SDOT) inspection and approval. Call prior to	☐ 5 star LEED Built Green 5 Star + 2030 Challenge			
construction: Commercial/Multifamily Zones, (206) 684-5693 Single Family Zones, (206) 684-7997 Street Lie Remits Call prior to constructions (206) 684-5883	☐ LEED Platinum + 2030 Challenge		ISSUED BY DATE	
Street Use Permits Call prior to construction: (206) 684-5283	Platinum			
Water Service Inspection by SPU Required All water service piping on property must be inspected prior to backfilling trench. For information and inspection, call Seattle Public Utilities (SPU) at (206) 684-5800. For water quality backflow protection information and inspection, call SPU at (206) 684-3536.	Seattle DCI Alternative Path for Single Family Target Performance Path Compliance Method			
Waste Diversion Report to be submitted to SPU - Projects >750 square feet must submit a Waste Diversion Report to SPU within 60 days of DCI project	Using 3.5 credits for SEC Table 9-1		BUILDING PLANS EXAMINER MECHANICAL PLANS EXAMINER DATE RECEIVED AT INTAKE	
final inspection approval. For information and submittal document: http://www.seattle.gov/util/ForBusinesses/Construction/CDWasteManagement/RecyclingRequirements/WasteDiversionReport/index.htm				

SEATTLE IRON & METALS

DUST CONTROL IMPROVEMENTS

NE SECTION 29, TOWNSHIP 24 NORTH, RANGE 4 EAST, W.M.


OWNER

SHALMAR 08, LLC
SEATTLE IRON & METALS CORP.
601 S. MYRTLE STREET
SEATTLE, WA 98108
(206) 682-0040
CONTACT: ALAN SIDELL

CONSULTANTS

CIVIL AND STRUCTURAL ENGINEER: KPFF CONSULTING ENGINEERS 2407 NORTH 31ST STREET, SUITE 100 TACOMA, WA. 98407 (253) 396-0150 CONTACT: IAN FRANK



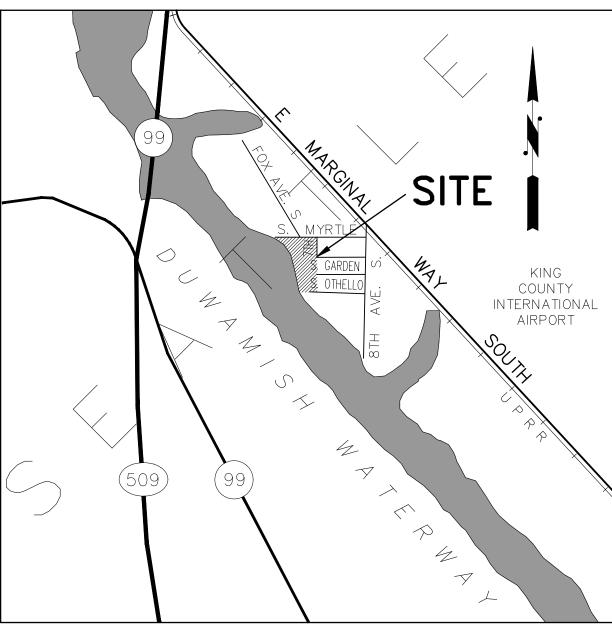

VICINITY MAP

PROJECT DATA

BENCHMARKS	HORIZONTAL DATUM: NAD 83/91 VERTICAL DATUM: NAVD 88 (ADD 2.99 TO ELEVATIONS TO OBTAIN MLLW) BENCHMARK: CITY OF SEATTLE BRASS CAP STAMPED "C OF S 5410" SET IN SW CORNER OF 4.6' TALL PLANTER BOX ATTACHED TO THE SW CORNER OF US WEST BUILDING AT THE NE CORNER OF THE INTERSECTION OF E MARGINAL WAY S AND CORSON AVE. S. ELEVATION = 22.333 NAVD88
SITE ADDRESS	601 S. MYRTLE STREET
ZONING	IG1, U85, UI

	DRAWING INDEX
SHEET NO.	DRAWING TITLE
G1.0	COVER SHEET
G1.1	LEGEND & ABBREVIATIONS
C1.0	OVERALL SITE PLAN
C2.0	CIVIL SITE PLAN
C3.0	CIVIL DETAILS
C3.1	CIVIL DETAILS
S1.0	STRUCTURAL NOTES
S2.0	STRUCTURAL SITE PLAN
S3.0	DE-DUSTING EQUIPMENT FOUNDATION
S4.0	WIND SCREEN 1 PLAN AND SECTION
S4.1	WIND SCREEN 2 PLAN AND SECTION
S4.2	WIND SCREEN 3 PLAN AND SECTION
S5.0	STRUCTURAL DETAILS

LEGAL DESCRIPTION

PARCEL A: #2136200706:

DUWAMISH INDUSTRIAL ADD PORS OF NE 1/4 OF SW 1/4 & OF SE 1/4 OF NW 1/4 STR 29-24-4 TGW POR OF ABANDONED BED OF DUWAMISH RVR LY IN SD 1/4 SECS TGW POR VAC S ORCHARD ST PER ORD #50034 TGW POR VAC S GARDEN ST POR ORD # 112815 REC #8605150946 TGW PORS OF LOTS 9 & 10 BLK 7 & TRS 21 THRU 23 SD PLAT DAF - BEG AT S QTR SEC COR OF SD SEC 29 TH N 00-57-26 E ALG THE CENTER LN OF SD SEC 29 A DIST OF 2256.41 FT TAP ON N MGN OF S GARDEN ST AS DEDICATED IN SD PLAT SD PT BEING THE TPOB TH W ALG SD MGN 353.23 FT TH S 00-00-00 E A DIST OF 60.00 FT TH W ALG THE S MGN OF GARDEN ST PROJECTED 418.36 FT TAP ON ELY MGN OF CWW DIST NO 1 TH N 43-32-00 W ALG SD ELY MGN 717.91 FT TAP ON S MGN OF S MYRTLE ST PROD WLY AS DEEDED TO CITY OF SEATTLE BY DEED UNDER NO 833369 TH S 89-59-17 E ALG SD S MGN 228.47 FT TH N 63-10-07 E A DIST OF 88.58 FT TO C/L OF S MYRTLE ST TH S 48-57-17 E A DIST OF 60.93 FT TO S MGN OF S MYRTLE ST PROD WLY & THE NW COR OF A TRACT OF LAND DEEDED UNDER NO 2733678 TH S 89-59-17 E ALG SD S MGN 581.76 FT TO WLY MGN OF 7TH AVE S TH S 00-00-43 W ALG SD W MGN 259.87 FT TO S MGN OF S ORCHARD ST TH CONT S 00-00-43 W A DIST OF 70.71 FT TH W A DIST OF 22.76 FT TH S 00-03-53 W A DIST OF 124.71 FT TAP THAT IS 5.00 FT N OF OF N MGN OF S GARDEN ST TH E ON A LN THAT IS PLW SD N MGN 401.93 FT THE E LN OF W 10.00 FT OF LOT 9 BLOCK 7 OF SD PLAT TH S 00-08-57 E ALG SD E LN 5.00 FT TO N MGN OF S GARDEN ST TH W A DIST OF 48.28 FT TO THE TPOB - AKA PARCEL B OF SEATTLE LOT BOUNDARY ADJUSTMENT NO 8708120 REC NO 8809140174 -- FORMERLY KNOWN AS A POR OF PARCEL A OF SEATTLE LLA NO 8600523 REC NO 8606171413


PARCEL B: #2924049089:

PORS OF ABANDONED BEDS OF DUWAMISH RIVER LY WITHIN NE 1/4 OF SW 1/4 STR 29-24-04 TGW THOSE PORS OF TRACTS 19 & 20 OF DUWAMISH INDUSTRIAL ADD DAF - BEG A S 1/4 SEC COR OF SD SEC 29 TH N 00-57-56 E ALG THE C/L OF SD SEC 29 A DIST OF 1976.47 FT TAP ON N MGN OF S OTHELLO ST AS DEDICATED IN SD PLAT TH N 89-58-57 W ALG SD R/W 477.56 FT TO SW COR OF SD TRACT 20 AND THE TPOB TH S 20-44-33 E A DIST OF 53.47 FT TO NW COR OF TRACT 16 OF SD PLAT TH S 10-03-29 W A DIST OF 38.93 FT TO ELY MGN OF CWW DIST NO 1 AND THE MOST MLY COR OF TRACT 16 TH N 49-00-00 W ALG SD ELY MGN 65.71 FT TAP OF NXN OF CWW DIST NO 1 MGNS TH CONT ALG SD ELY MGN N 43-32-00 W A DIST OF 365.49 FT TO S LN OF S GARDEN ST PROJECTED WLY TH ALG SD PROJECTION LN AND THE S MGN OF S GARDEN ST AND THE N LN OF SD TRACTS 19 & 20 E A DIST OF 369.87 FT TAP ON A LN THAT IS 700.00 FT W OF AND PLW THE E LN OF TRACT 17 OF SD PLAT TH S 00-08-57 E A DIST OF 219.78 FT TO N MGN OF S OTHELLO ST AND THE S LN OF SD TRACT 20 TH N 89-58-57 W A DIST OF 81.24 FT ALG SD MGN TO THE TPOB - AKA PARCEL A OF SEATTLE LOT BOUNDARY ADJUSTMENT NO 8708120 REC NO 8809140174.

PROJECT DESCRIPTION

THE WORK INCLUDES CONSTRUCTION OF CONCRETE FOUNDATIONS TO SUPPORT A DEDUSTER SYSTEM AND SUPPORTS FOR WIND SCREEN. THE FRAMING AND DEDUSTING SYSTEM WILL BE DESIGNED BY THE DEDUSTING MANUFACTURER. THE WIND SCREEN SYSTEM WILL BE DESIGNED BY THE WIND SCREEN MANUFACTURER.

8-18-1000

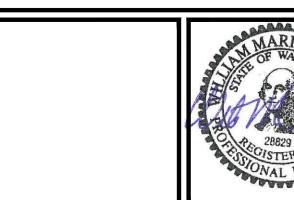

ION	NO.	DATE	BY	REVISION	
REPUBLIC					
ENGL					

SEATTLE IRON AND METALS
DUST CONTROL IMPROVEMENTS

COVER SHEET

	DRAWN: TRL	PROJECT NO.: 1900195
	DESIGN: KCP	SCALE: AS SHOWN
	CHECKED: IDF	DATE: 8/10/2020
	DRAWING NO.	G1.0
ı	SHEET NO.	01 OF 13

POUNDS PER SQUARE INCH

POLYVINYL CHLORIDE OR

PAVEMENT

REFERENCE

REQUIRED

RAILROAD

RIGHT

RIGHT HAND

RADIUS POINT

STORM DRAIN

SOUTH-EAST

SPECIFICATIONS

SQUARE FEET

SECTION

SQUARE

STATION

STEEL

TOP OF

STANDARD

SOUTHWEST

THRUST BLOCK

TRACK FEET

TOP OF BANK

TOE OF SLOPE

TOP OF PIPE

TOP OF RAIL

TOP OF WALL

ULTRA-VIOLET

VARIABLE or VARIES

VITRIFIED CLAY PIPE

WATER, WEST, WIDTH

WELDED HEADED STUD

VERTICAL CURVE

TYPICAL

VERTICAL

VERTICAL

WITHOUT

WASTE OIL

WALKWAY

CROSSOVER

EXTRA STRONG

WATER METER

WITH

TURNOUT

TOP AND BOTTOM

SHEET SIMILAR

SLOPE OR SOUTH

ROAD

RIDE OR RADIUS

RIGHT OF WAY

POINT OF VERTICAL CURVE

POINT or POINT OF TANGENCY

REINFORCED CONCRETE PIPE

REINFORCE OR REINFORCING

STANDARD DIMENSION RATIO

SANITARY SEWER MANHOLE

SYMMETRIC or SYMBOL

TEMPORARY BENCH MARK

TEMPORARY EROSION AND

SEDIMENTATION CONTROL

TACOMA PUBLIC UTILITIES

UNDERWRITERS LABORATORY

UNLESS NOTED OTHERWISE

STORM DRAIN MANHOLE

POINT OF VERTICAL INTERSECTION

PSI

PVC

PVI

RCP

REF

REINF

REQ'D

RH

RP

RR

RT.

SD

SDR

SE

SDMH

SECT

SHT

SIM

SQ

SSMH

STA

STD

STL

SW

SYM

TBM

TESC

T&B

TOB

TOS

TOP

TOR

TPU

TW

TYP

UNO

VAR

VCP

VERT

W/0

WHS

WM

WOIL

WWAY

ΧO

XS

UL

U٧

TO

SPECS

RD

PVMT

R/W OR ROW

PΤ

LEGEND

SITE LOCATION POINT

4444444

CONCRETE PAVEMENT

HMA PAVEMENT EX PAVEMENT TO REMAIN

PRECAST CONCRETE TRACK PANEL

DEMOLISH PAVEMENT

EXISTING RAIL

EXISTING TRACK Q

DEMOLISH TRACK

WATER LINE

COMPRESSED AIR LINE

SEWER DISCHARGE POINT

SANITARY SEWER LINE (BURIED)

OORT

ORT DISCHARGE POINT

REMOVABLE CONCRETE PIPE BOLLARD

PROJECT LIMITS

TRENCH DRAIN

EDGE OF ASPHALT

WALL

ELECTRICAL METER PI ELECTRICAL CABINET \triangle TRANSFORMER

 \mathbb{Q}_{T}

LIGHT J-BOX OVERHEAD LIGHT

ОСП V

FROG

STORM CLEAN OUT

WATER VAULT

RAILROAD FROG


UNKNOWN UTILITY VAULT

RAILROAD MANUAL SWITCH/NUMBER

2407 North 31st Street, Suite 100

Tacoma, Washington 98407 (253) 396-0150 Fax (253) 396-0162


Plotted: Aug 18, N: \2019\1900195

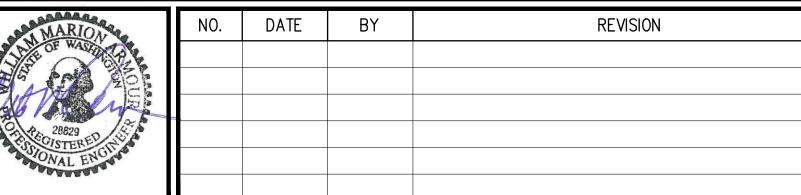

SEATTLE IRON AND METALS DUST CONTROL IMPROVEMENTS

LEGEND AND ABBREVIATIONS

DRAWN: TRL	PROJECT NO.: 1900195
DESIGN: KCP	SCALE: AS SHOWN
CHECKED: IDF	DATE: 8/10/2020
DRAWING NO.	
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SHEET NO.	02 OF 13

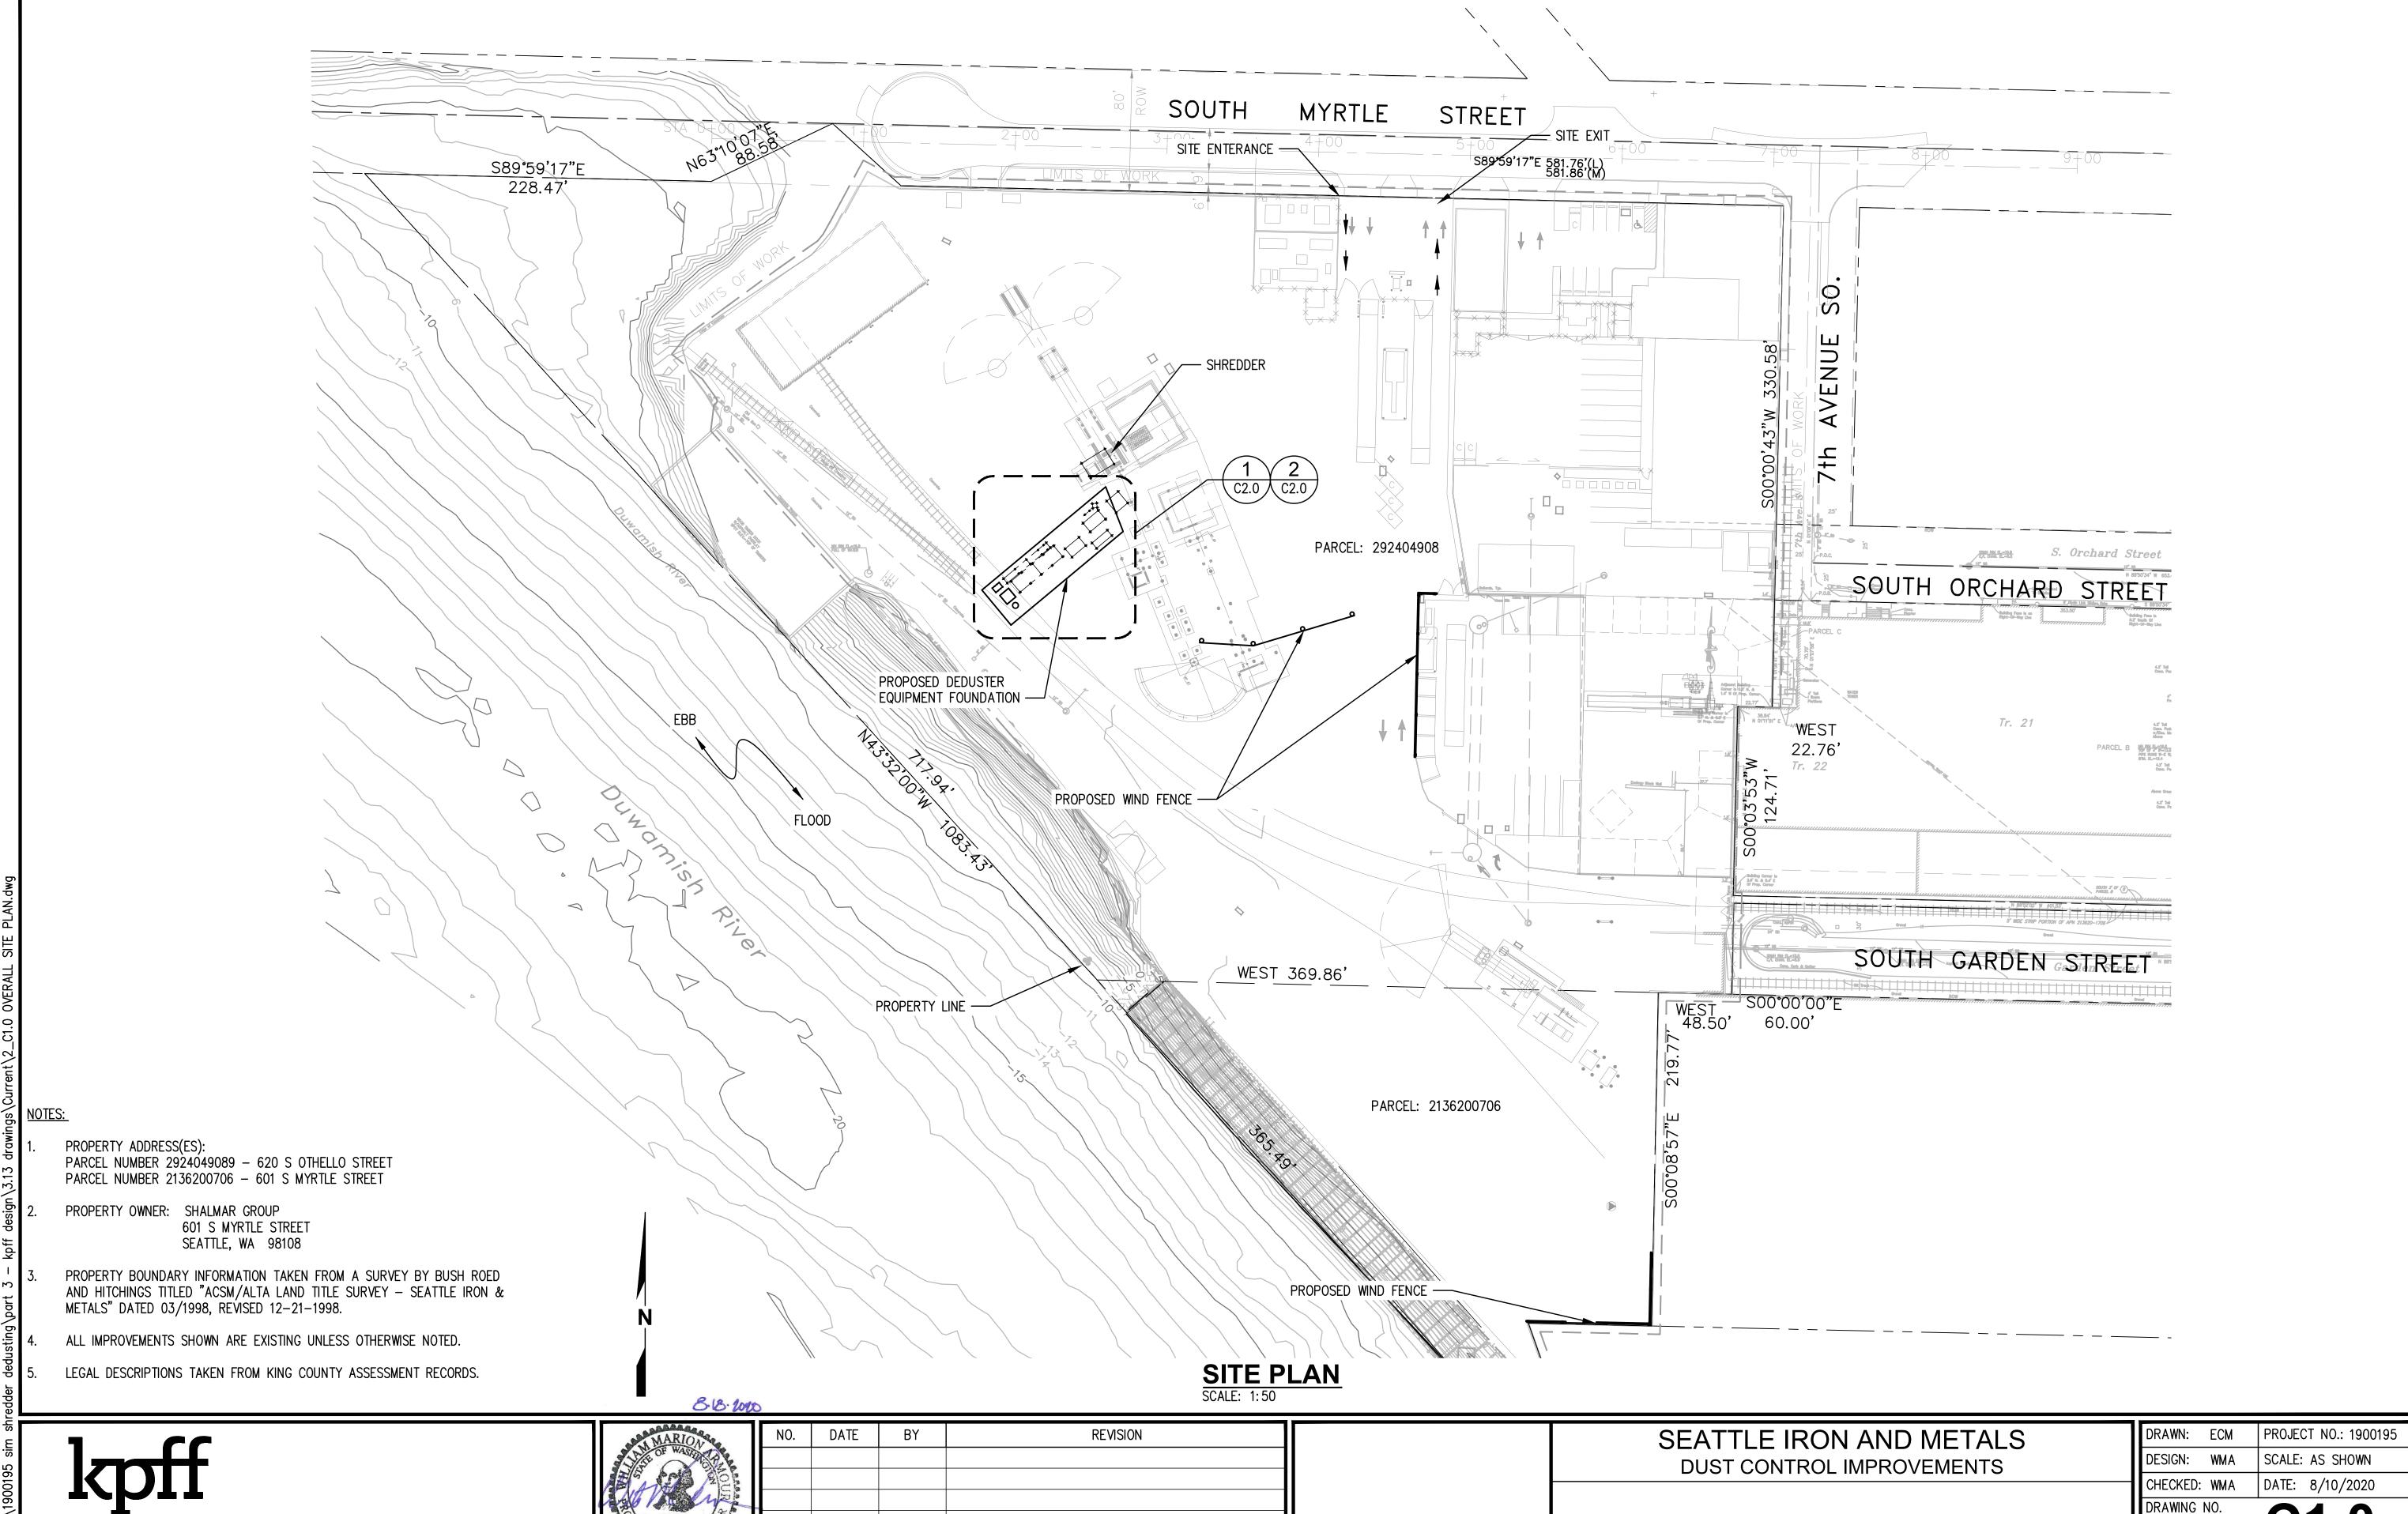


OVERALL SITE PLAN

03 OF **13**

SHEET NO.

Plotted: Aug 18, 2020 — 3:41pm emoates Layout: C1.0 OVERALL SI

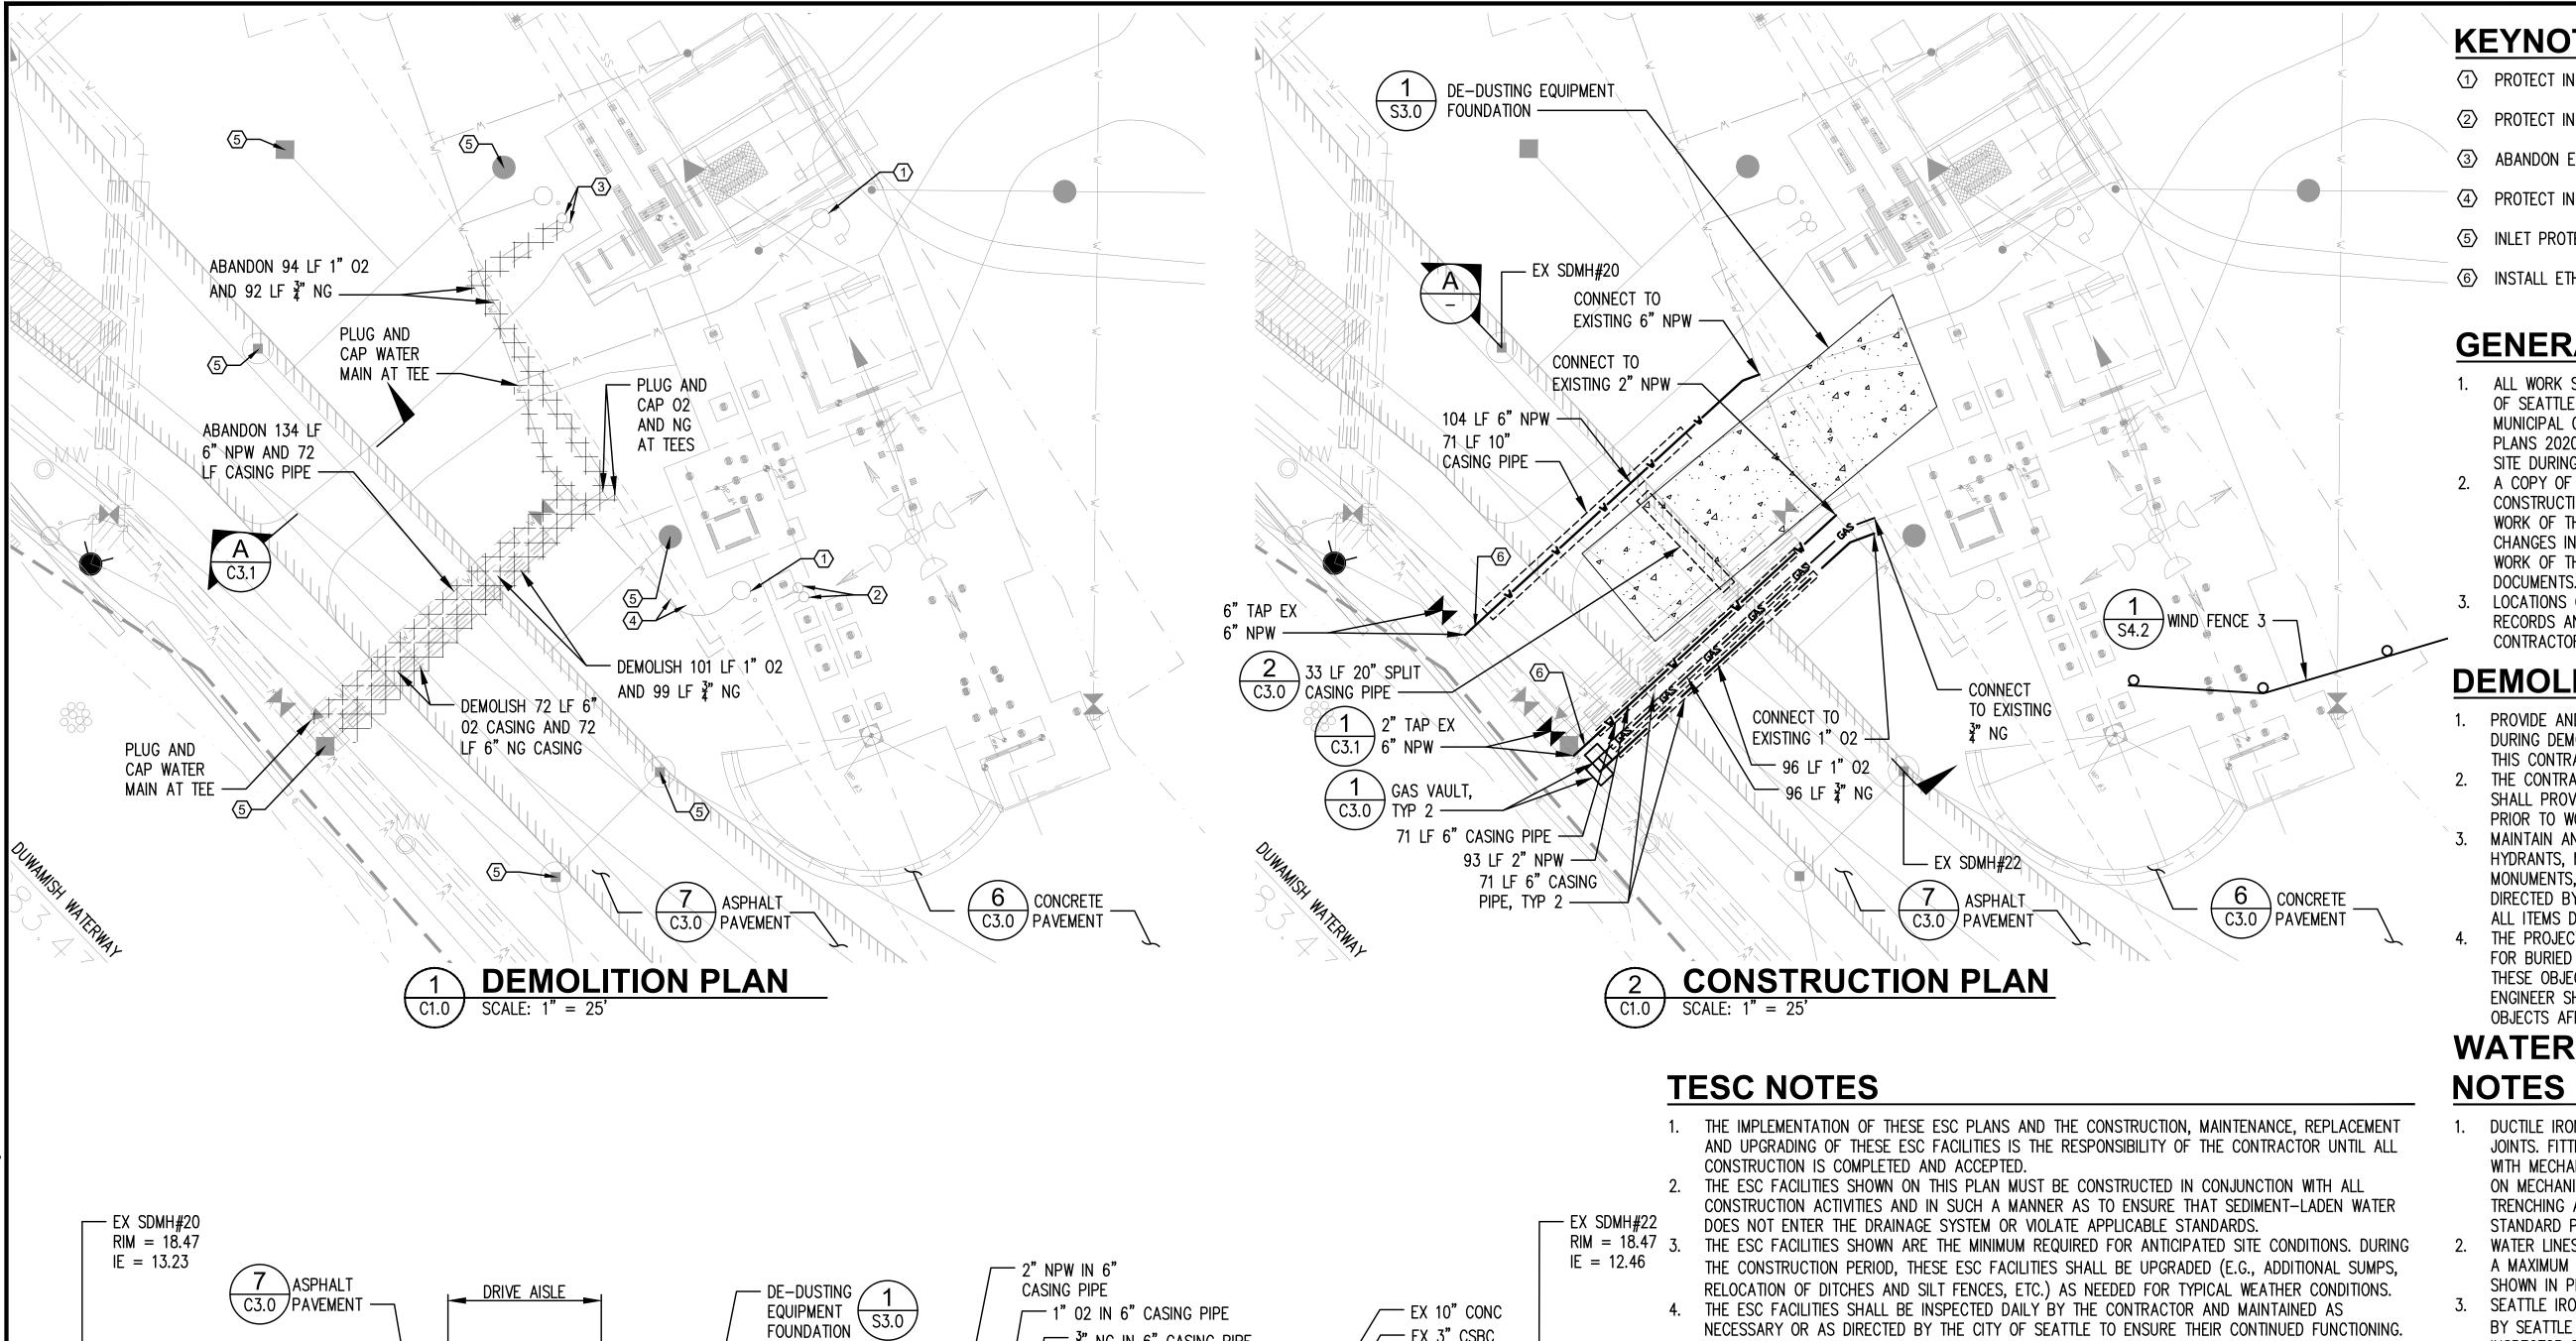

— EX 3" CSBC

- 5. THE ESC FACILITIES ON-SITE SHALL BE INSPECTED AND MAINTAINED DURING AND AFTER EACH RAIN EVENT. OR A MINIMUM OF ONCE A MONTH.
- THE APPROVAL OF THE EROSION/SEDIMENTATION CONTROL PLAN DOES NOT CONSTITUTE AN APPROVAL OF PERTINENT ROAD OR DRAINAGE DESIGN (E.G., SIZE AND LOCATION OF ROADS, PIPES, RESTRICTORS, CHANNELS, RETENTION FACILITIES, UTILITIES, ETC.).
- ALL EROSION AND SEDIMENTATION CONTROL BEST MANAGEMENT PRACTICES (BMPS) SHALL BE MAINTAINED AND REPAIRED AS NEEDED TO ASSURE CONTINUED PERFORMANCE OF THEIR INTENDED FUNCTION. ALL MAINTENANCE AND REPAIR SHALL BE CONDUCTED IN ACCORDANCE WITH THE CITY OF SEATTLE'S CONSTRUCTION BEST MANAGEMENT PRACTICES MANUAL AND ALL OTHER APPLICABLE STANDARDS AND REGULATIONS.
- ANY AREA NEEDING ESC MEASURE, BUT NOT REQUIRING IMMEDIATE ATTENTION, SHALL BE ADDRESSED WITHIN 15 DAYS.
- CONTRACTOR SHALL VERIFY EXTENT OF SILTATION WITHIN CONVEYANCE SYSTEM PRIOR TO START OF CONSTRUCTION. AT NO TIME SHALL MORE THAN 1 FOOT OF SEDIMENT BE ALLOWED TO ACCUMULATE WITHIN A CATCH BASIN. ALL CATCH BASINS AND CONVEYANCE LINES SHALL BE CLEANED PRIOR TO PAVING. THE CLEANING OPERATION SHALL NOT FLUSH SEDIMENT-LADEN WATER INTO THE DOWNSTREAM SYSTEM.
- 10. IF SEDIMENT IS TRANSPORTED ONTO A ROAD SURFACE, THE ROADS SHALL BE CLEANED THOROUGHLY AT THE END OF EACH DAY. SEDIMENT SHALL BE REMOVED FROM ROADS BY A METHOD AS APPROVED BY THE ENGINEER AND BE TRANSPORTED TO A CONTROLLED SEDIMENT DISPOSAL AREA. STREET WASHING SHALL BE ALLOWED ONLY AFTER SEDIMENT IS REMOVED IN THIS MANNER.

KEYNOTES

- PROTECT IN PLACE EXISTING NPW APPURTENANCE
- 2 PROTECT IN PLACE EXISTING 02 AND NG APPURTENANCE
- 3 ABANDON EXISTING 02 AND NG APPURTENANCE
- 4 PROTECT IN PLACE EXISTING 02 AND NG PIPE
- 5 INLET PROTECTION
- 6 INSTALL ETHA FOAM CUSHION UTILITY CROSSING AS REQUIRED

GENERAL NOTES

- ALL WORK SHALL CONFORM TO THE CURRENT EDITION OF THE CITY OF SEATTLE STANDARD SPECIFICATIONS FOR ROAD, BRIDGE, AND MUNICIPAL CONSTRUCTION AND THE CITY OF SEATTLE STANDARD PLANS 2020 EDITION. A COPY OF THESE DOCUMENTS SHALL BE ON SITE DURING CONSTRUCTION.
- A COPY OF THE APPROVED PLAN SHALL BE ON SITE WHENEVER CONSTRUCTION IS IN PROGRESS. THROUGHOUT THE PROGRESS OF THE WORK OF THIS CONTRACT, MAINTAIN AN ACCURATE RECORD OF ALL CHANGES IN THE CONTRACT DOCUMENTS. UPON COMPLETION OF THE WORK OF THIS CONTRACT, PROVIDE ONE COMPLETE SET OF RECORD
- LOCATIONS OF EXISTING UTILITIES OBTAINED FROM AVAILABLE RECORDS AND ARE APPROXIMATE AND NOT NECESSARILY COMPLETE. CONTRACTOR TO VERIFY FIELD LOCATION OF ALL UTILITIES.

DEMOLITION NOTES

- PROVIDE AND MAINTAIN TEMPORARY EROSION AND SEDIMENT CONTROL DURING DEMOLITION AND THROUGHOUT THE PROGRESS OF THE WORK OF THIS CONTRACT
- THE CONTRACTOR SHALL VERIFY THE LOCATION OF ALL UTILITIES AND SHALL PROVIDE SUFFICIENT NOTIFICATION TO THE APPROPRIATE UTILITY
- MAINTAIN AND PROTECT ALL MANHOLES, CATCH BASINS, FIRE HYDRANTS, MONITORING WELLS, WATER VALVES, PIPING, SURVEY MONUMENTS, AND WATER METERS, UNLESS OTHERWISE NOTED OR DIRECTED BY THE ENGINEER. CONTRACTOR SHALL REPAIR OR REPLACE
- ENGINEER SHALL BE NOTIFIED IMMEDIATELY IF ANY UNIDENTIFIED OBJECTS AFFECTING CONSTRUCTION PROGRESS ARE ENCOUNTERED.

WATER AND SANITARY SEWER

- DUCTILE IRON PIPE SHALL BE CLASS 52 WITH PUSH-ON JOINTS. FITTINGS AND JOINTS SHALL BE DUCTILE CLASS 52 WITH MECHANICAL JOINTS, UNLESS OTHERWISE NOTED. GLANDS ON MECHANICAL JOINT PIPE AND FITTINGS SHALL BE DUCTILE. TRENCHING AND BEDDING SHALL BE PER CITY OF SEATTLE STANDARD PLAN.
- WATER LINES SHALL HAVE A MINIMUM COVER OF 3 FEET AND A MAXIMUM COVER OF 6 FEET. EXCEPTIONS SHALL BE ONLY AS SHOWN IN PLANS OR AS APPROVED BY THE ENGINEER.
- SEATTLE IRON & METALS WATER SYSTEM SHALL BE INSPECTED BY SEATTLE WATER DEPARTMENT (SWD) WATER SERVICE INSPECTOR PRIOR TO BACKFILLING. THE CONTRACTOR SHALL COORDINATE WITH SWD.
- 4. ENTIRE WATER SYSTEM IS A RESTRAINT JOINT SYSTEM. CONTRACTOR SHALL USE MEGA LUG, UNI-FLANGE AND FIELD LOK JOINT RESTRAINED (RJ) SYSTEM UNLESS SHOWN OTHERWISE ON DRAWINGS.



-0+0.00+00

6" NPW IN 10"

33 LF 20" SPLIT

CASING PIPE —

EX 153 LF 12" PSD @ 0.005

C3.0

CASING PIPE ---

EX 6" NPW IN


10" CASING PIPE

EX 1" 02 IN 6" CASING PIPE ——

EX $\frac{3}{4}$ " NG IN 6" CASING PIPE —

SITE SECTION

SCALE: 1" = 10' HORZ, 1" = 5' VERT

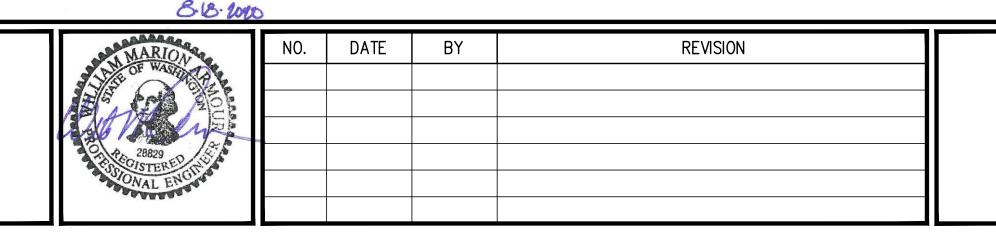



 $rac{3}{4}$ " NG IN 6" CASING PIPE

SEATTLE IRON AND METALS DUST CONTROL IMPROVEMENTS


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CIVIL SITE PLAN



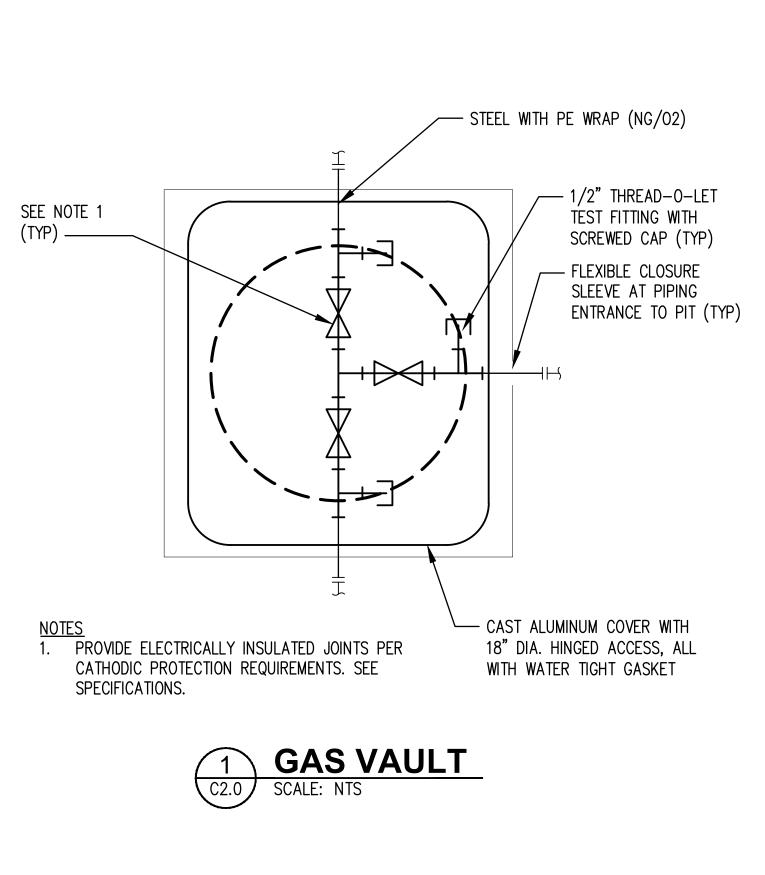

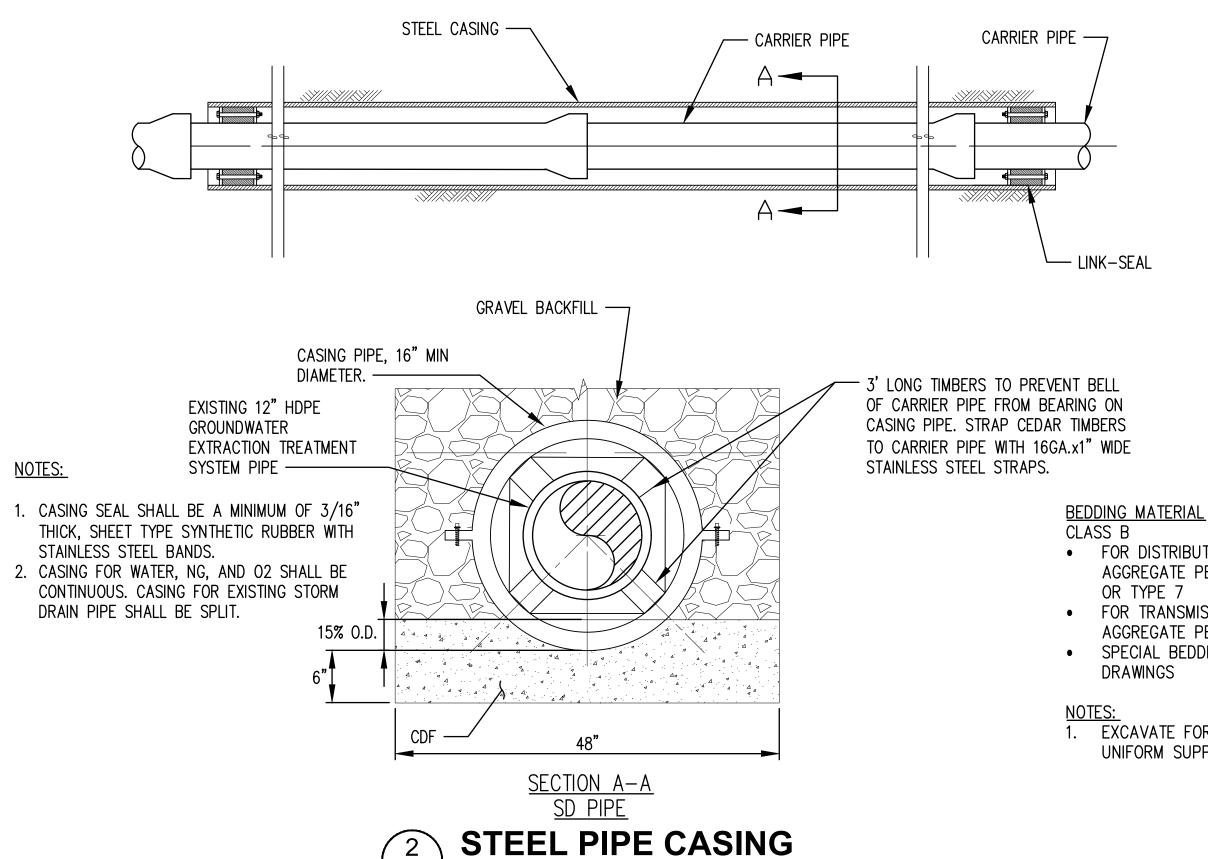SCALE: NTS

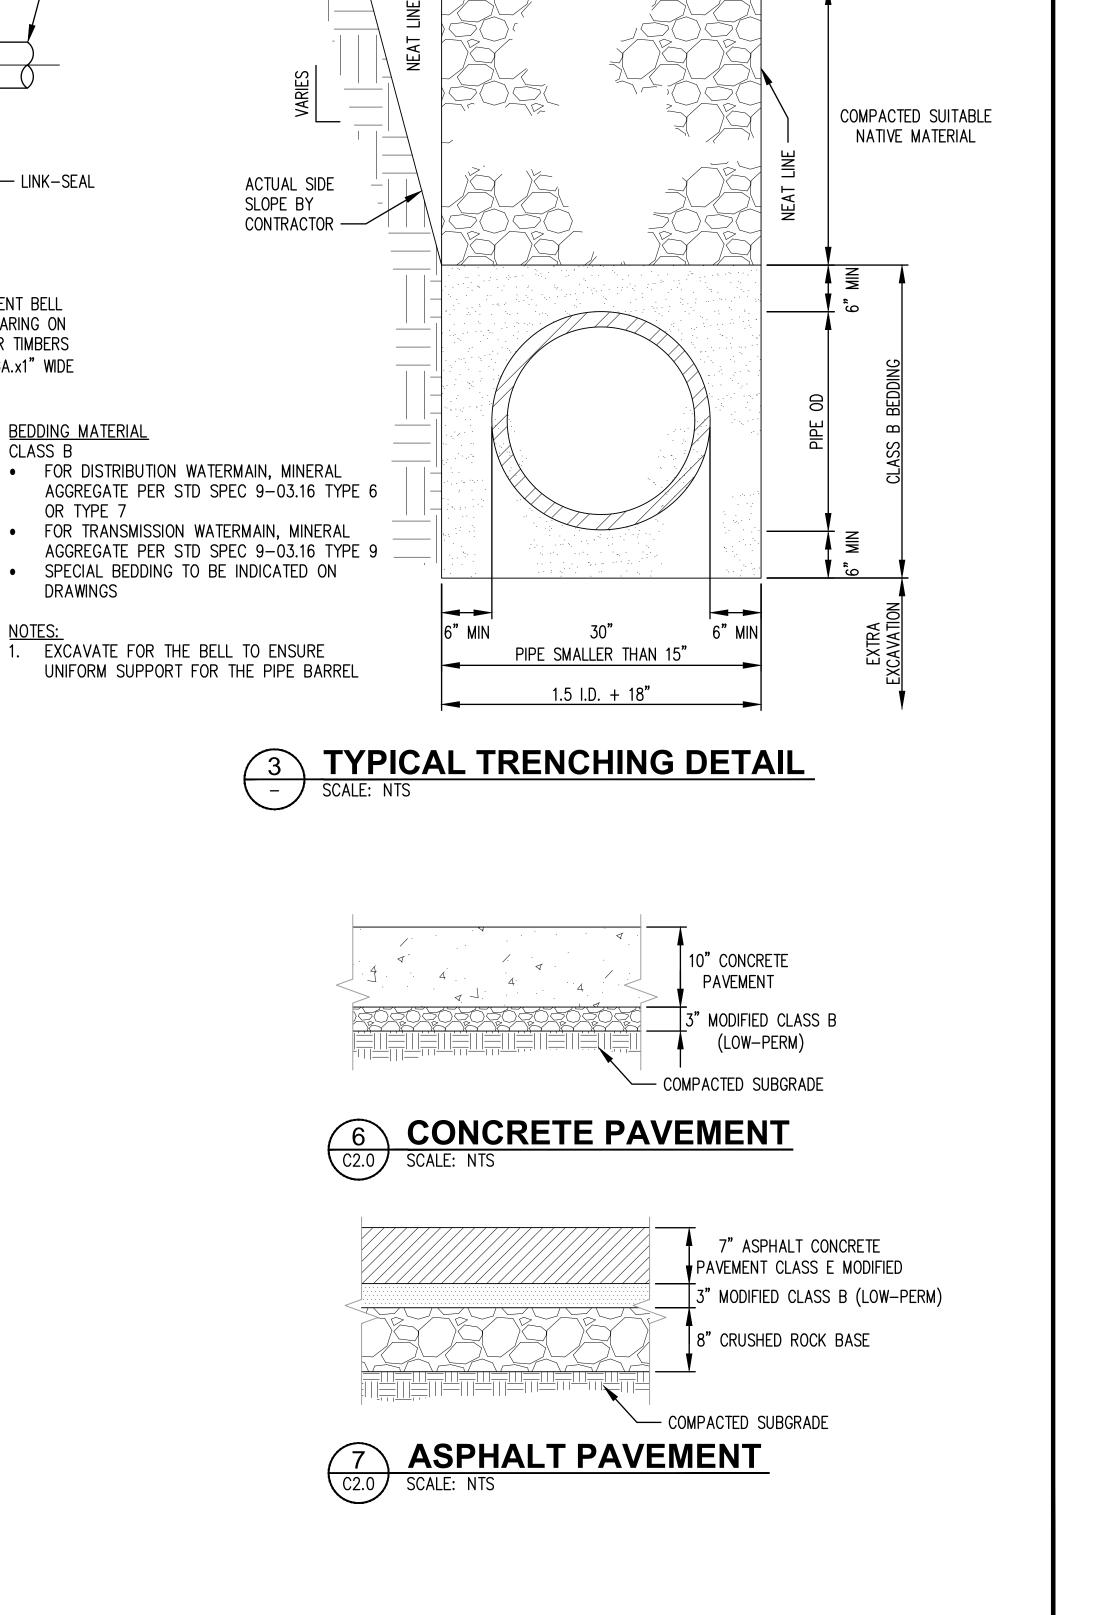


NEAT LINE WIDTH FOR **EXCAVATION & BACKFILL**

— FINISH GRADE


PAVEMENT RESTORATION PER STD PLAN NOS

404a & 404b

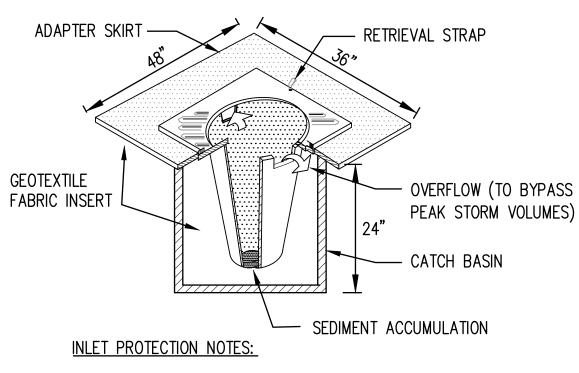


1. FILTERS SHALL BE INSPECTED AFTER EACH STORM EVENT AND CLEANED OR REPLACED WHEN 1/3

INLET PROTECTION C2.0 SCALE: NTS

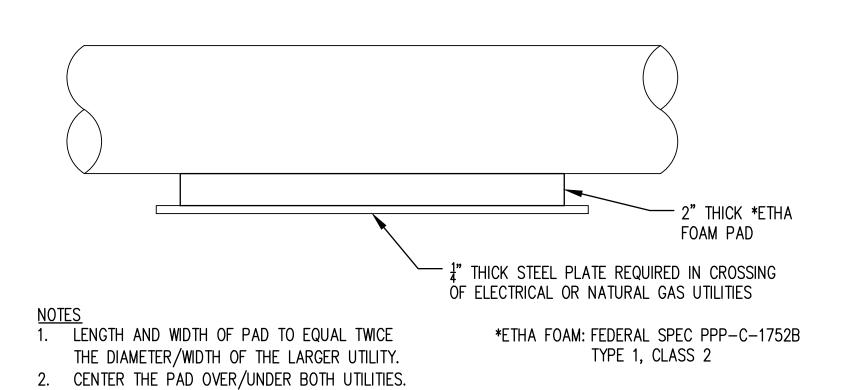

ETHA FOAM CUSHION **UTILITY CROSSING** C2.0 SCALE: NTS



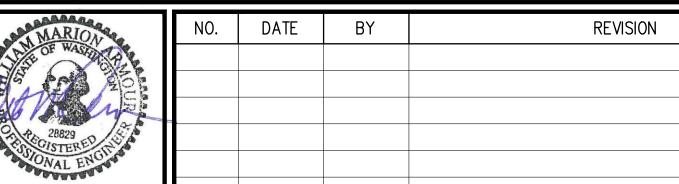


SEATTLE IRON AND METALS DUST CONTROL IMPROVEMENTS

PROJECT NO.: 1900195 DRAWN: ECM SCALE: AS SHOWN DESIGN: WMA DATE: 8/10/2020 CHECKED: WMA DRAWING NO. **05** OF **13** SHEET NO.

8-18-2020

Tacoma, Washington 98407 (253) 396-0150 Fax (253) 396-0162 **CIVIL DETAILS**

FABRIC INSERT

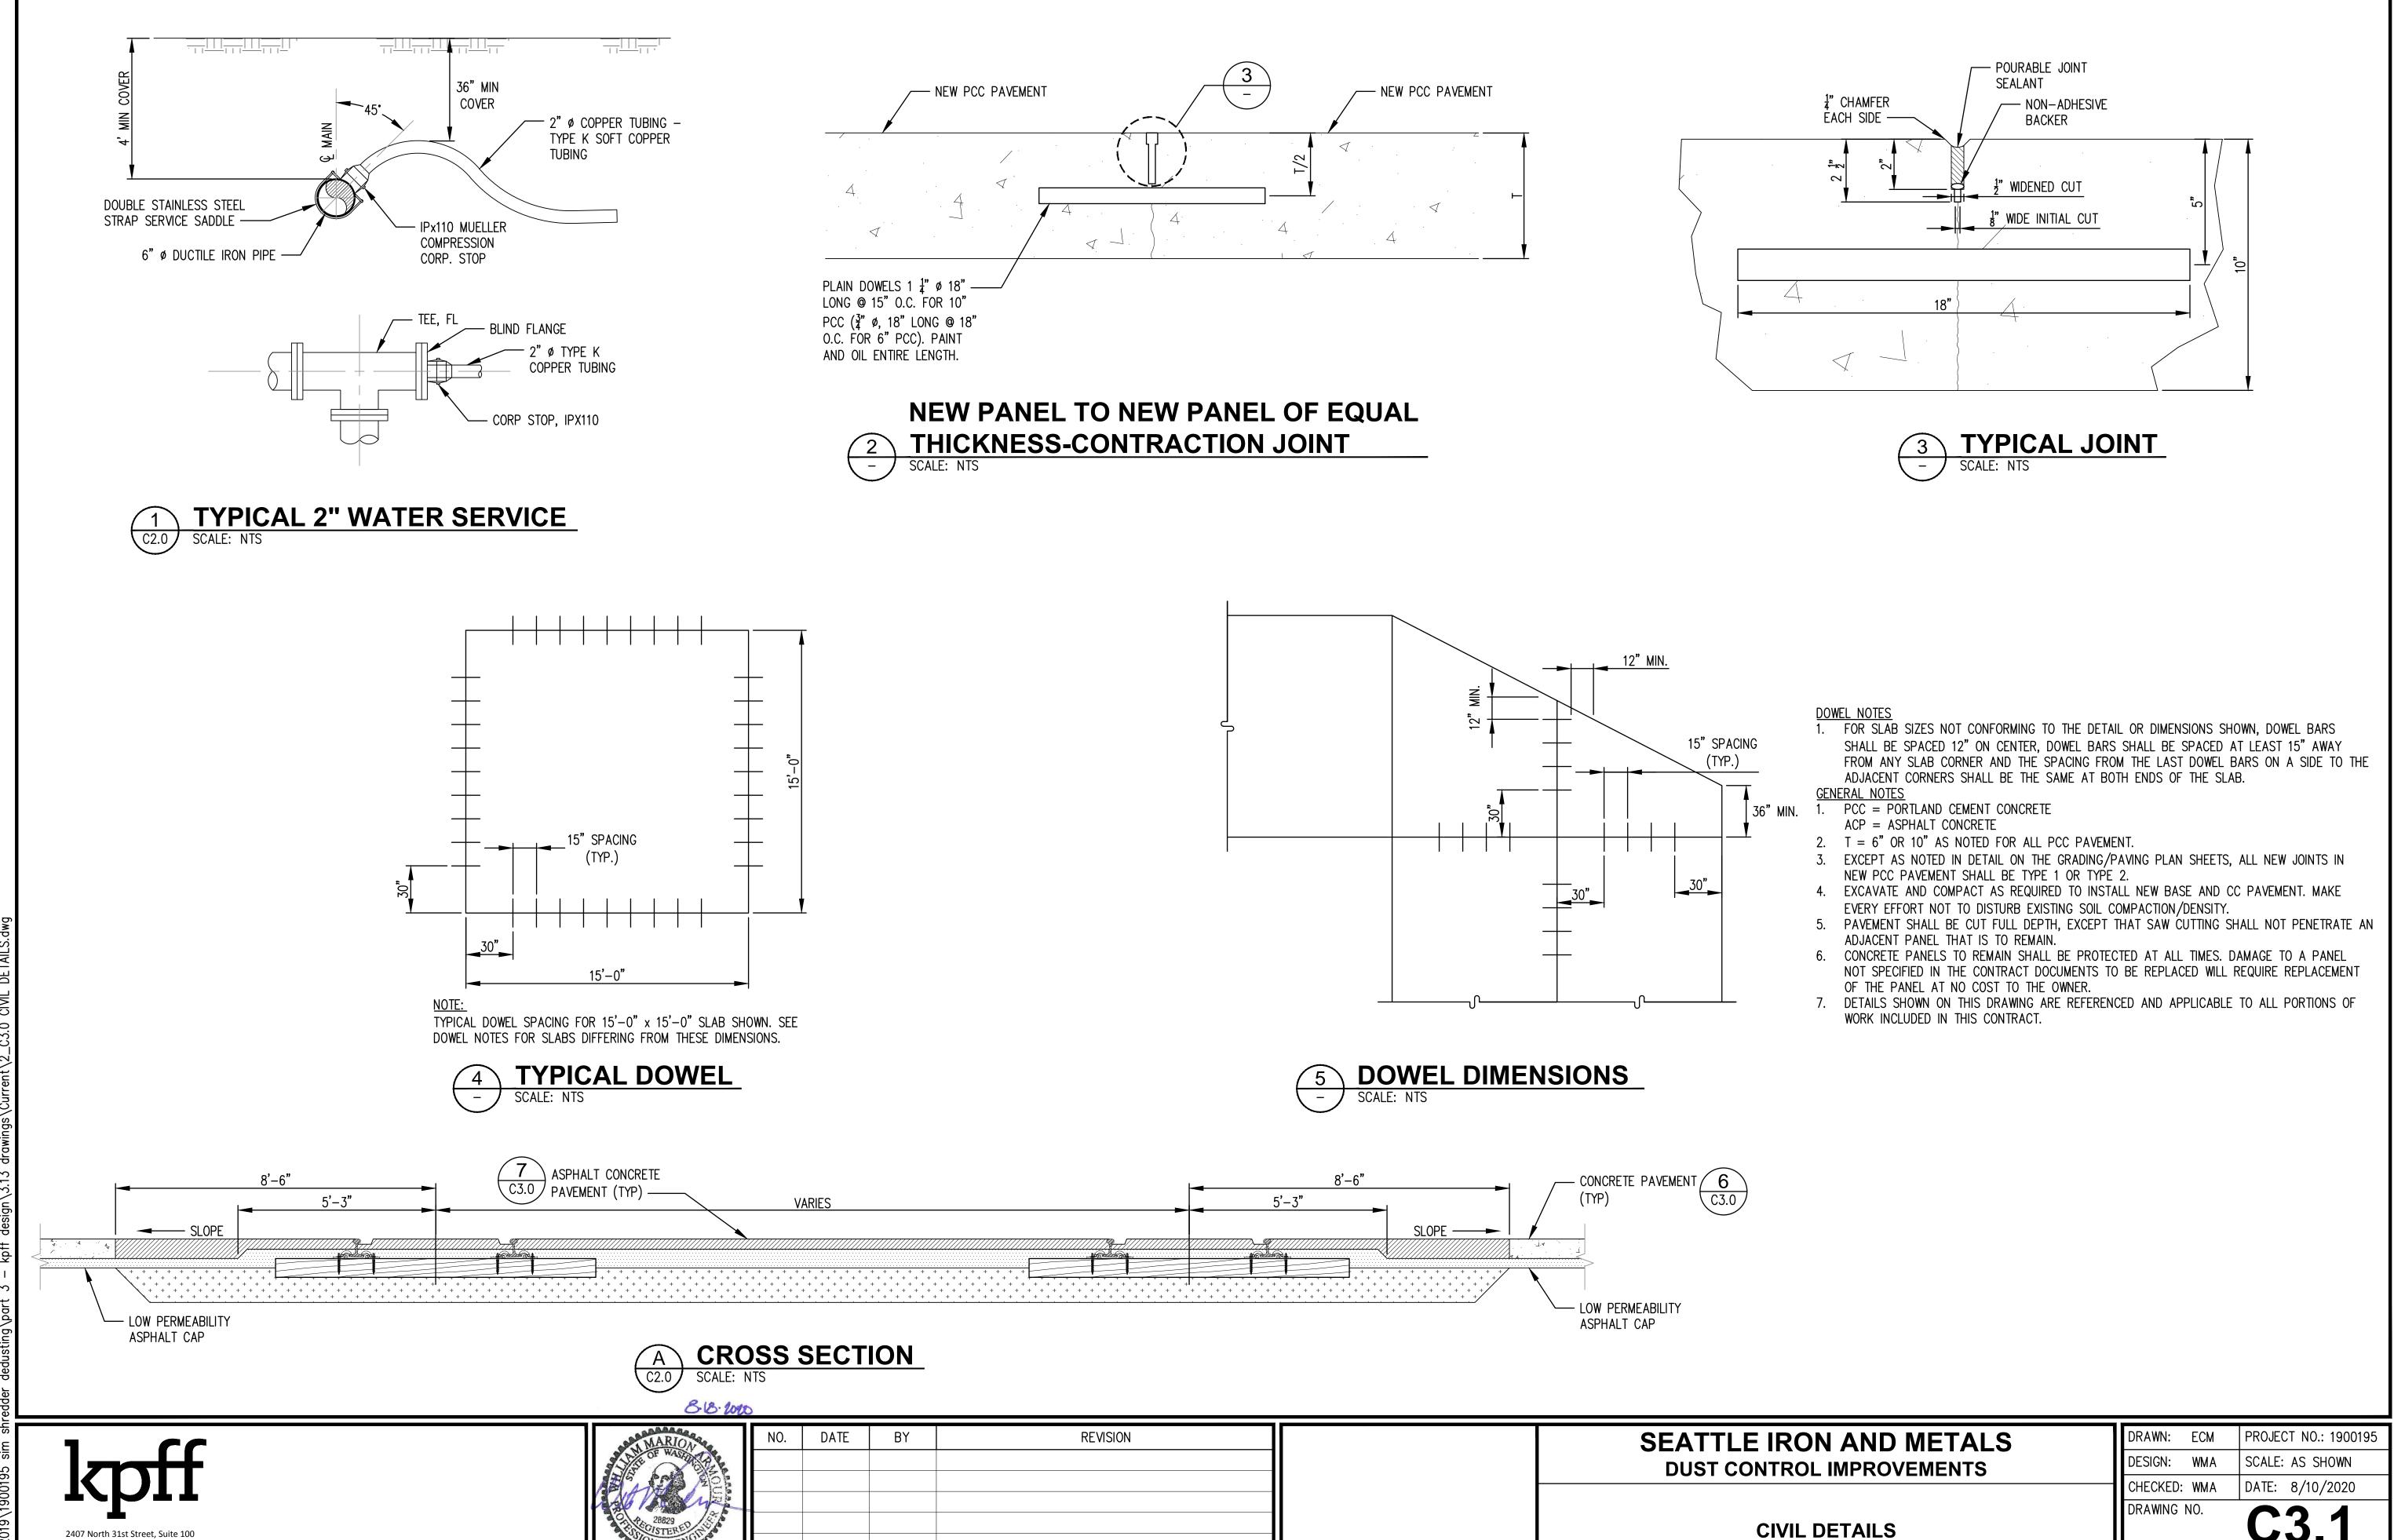

06 OF **13**

SHEET NO.

Plotted: Aug 18, 2020 — 3:01pm tlemons Layout: C3.1 CIVIL DETAILS

Tacoma, Washington 98407 (253) 396-0150 Fax (253) 396-0162

DESIGN CRITERIA

CODES AND STANDARDS 2015 SEATTLE BUILDING CODE DEAD LOADS: SELF WEIGHT OF ALL MATERIALS

EQUIPMENT LOADS:

REACTIONS AT EQUIPMENT SUPPORTS PROVIDED BY MANUFACTURER FOR EACH LOAD COMBINATION CONSIDERED.

WIND LOADS:

WIND LOADS FOR THE WIND SCREEN SYSTEM WERE PROVIDED BY WEATHER SOLVE STRUCTURE INC. IN ACCORDANCE WITH THE WIND TUNNEL PROCEDURE SPECIFIED IN ASCE 7-10 CH 31.

<u>SEISMIC LOADS:</u>		
SITE CLASS E.		
RISK CATEGORY	II.	
SEISMIC DESIGN	CATEGORY	D.

WIND LOADS: EXPOSURE CATEGORY C RISK CATEGORY I

V = 110 mph

1.519G

0.582G $K_d = 0.85$ = 0.911G G = 1.0= 0.932G

LOAD COMBINATIONS:

- 1. 1.4D
- $2. \quad 1.2D + 1.6L + 0.5S$
- 3. 1.2D + 1.6S + L
- 4. 1.2D + 1.6S + 0.5W5. 1.2D + L + 0.5S + W
- 6. $(1.2 + 0.2S_{ps})D+L+E$
- 7. 0.9D + W

8. $(0.9-0.2S_{ps})D+E$ **CODES AND STANDARDS**

- 1. ALL METHODS AND MATERIALS SHALL CONFORM TO THE 2015 SEATTLE BUILDING CODE
- REINFORCED CONCRETE WORK SHALL CONFORM TO THE REQUIREMENTS OF "SPECIFICATIONS FOR STRUCTURAL CONCRETE FOR BUILDINGS" (ACI 301) AND "BUILDING CODE REQUIREMENTS FOR REINFORCED CONCRETE" (ACI 318). LATEST EDITIONS.

GENERAL

- THE CONTRACTOR SHALL BE RESPONSIBLE FOR ALL CONSTRUCTION SAFETY, METHODS, TECHNIQUES, SEQUENCES, OR PROCEDURES REQUIRED TO PERFORM THE WORK.
- PRIOR TO THE START OF CONSTRUCTION. THE CONTRACTOR SHALL VERIFY THAT ALL REQUIRED PERMITS AND APPROVALS HAVE BEEN OBTAINED. NO CONSTRUCTION OR FABRICATION SHALL BEGIN UNTIL THE CONTRACTOR HAS RECEIVED AND THOROUGHLY REVIEWED ALL PROJECT PLANS AND OTHER CONSTRUCTION NOTES.

SURVEY AND FIELD VERIFICATION

CONTRACTOR SHALL VERIFY ALL LEVELS. DIMENSIONS. AND EXISTING CONDITIONS IN THE FIELD BEFORE PROCEEDING. CONTRACTOR SHALL NOTIFY THE OWNER OF ANY DISCREPANCIES OR FIELD CHANGES PRIOR TO INSTALLATION OR FABRICATION. IN CASE OF DISCREPANCIES BETWEEN THE EXISTING CONDITIONS AND THE DRAWINGS, THE CONTRACTOR SHALL OBTAIN DIRECTION FROM THE OWNER BEFORE PROCEEDING. DIMENSIONS NOTED AS PLUS OR MINUS (+/-) OR "REF" INDICATE UNVERIFIED DIMENSIONS AND ARE APPROXIMATE. NOTIFY THE OWNER IMMEDIATELY OF CONFLICTS OR EXCESSIVE VARIATIONS FROM INDICATED DIMENSION. NOTED DIMENSIONS TAKE PRECEDENCE OVER SCALED DIMENSIONS - DO NOT SCALE DRAWINGS. DIMENSIONS OF EXISTING CONDITIONS MAY BE BASED ON RECORD DRAWINGS AND ARE TO BE FIELD VERIFIED BY THE CONTRACTOR.

PILING

Aug 18, 3 1900195

PILES SHALL BE DRIVEN TO THE MINIMUM EMBEDMENT DEPTH INDICATED IN ACCORDANCE WITH THE GEOTECHNICAL REPORT BY PANGEO DATED 8/17/2020.

DEFERRED SUBMITTAL

THE DESIGN OF THE WIND SCREEN SYSTEM INCLUDING COLUMNS, FABRIC & ATTACHMENTS WILL BE BY OTHERS & WILL BE SUBMITTED TO THE CITY OF SEATTLE FOR REVIEW. THE DESIGN OF THE DEDUSTING SUPPORT FRAMING WILL BE BY OTHERS AND WILL BE SUBMITTED TO THE CITY OF SEATTLE FOR REVIEW.

SUBMITTALS

CONTRACTOR SHALL PROVIDE EACH SUBMITTAL TO ENGINEER FOR APPROVAL A MINIMUM OF 2 WEEKS PRIOR TO START OF THE RELATED ACTIVITY.

- 1. CONSTRUCTION WORK PLAN INCLUDING PILE DRIVING WORK PLAN
- 2. CONSTRUCTION SCHEDULE
- 3. CONCRETE MIX DESIGN
- 4. MATERIAL CERTIFICATIONS AND CUT SHEETS
- 5. FABRICATION DRAWINGS
- 6. WELDER QUALIFICATIONS
- 7. ALL SHOP DRAWINGS FOR FORM WORK, FALSE WORK, STRUCTURAL STEEL, REINFORCING STEEL, AND MISCELLANEOUS STEEL, SHALL BE SUBMITTED TO AND REVIEWED BY THE ENGINEER PRIOR TO FABRICATION

DEMOLITION

- CONCRETE EDGES TO REMAIN SHALL BE CUT BACK AND SQUARED OFF TO ELIMINATE FEATHER EDGES IN ABUTTING CONCRETE.
- 2. CLEAN THE SITE AFTER REMOVAL OF ALL DEMOLITION ITEMS AND MATERIALS. THERE SHALL BE NO DEBRIS, RUBBLE OR LITTER LEFT AT THE SITE FROM ANY OF THE CONTRACTOR'S OPERATIONS.

STRUCTURAL STEEL

- 1. ALL PIPE PILES SHALL CONFORM TO ASTM A252 GRADE 3(MOD) Fy = 50 KSI
- 2. ALL MISCELLANEOUS STEEL SHAPES AND PLATES, EXCEPT AS NOTED BELOW, SHALL CONFORM TO ASTM A 36.
- 3. ALL ANCHOR BOLTS SHALL CONFORM TO ASTM F 1554, GRADE 36 (TYPICAL).
- 4. ALL NUTS SHALL BE ASTM A 563, UNLESS NOTED OTHERWISE.
- 5. ALL WASHERS SHALL BE ASTM F 436, UNLESS NOTED OTHERWISE.
- 6. ALL STEEL ITEMS SHALL BE HOT-DIP GALVANIZED AND/OR COATED AS SPECIFIED.

ANCHORS

- 1. USE OF DRILLED ADHESIVE CONCRETE ANCHORS, WHERE NOT SPECIFIED IN THE DOCUMENTS, SHALL BE SUBJECT TO APPROVAL BY THE ENGINEER.
- EPOXY OR ADHESIVE-TYPE ANCHORS SHALL BE INSTALLED PER THE MANUFACTURER'S RECOMMENDATION. SPECIAL INSPECTION IS REQUIRED FOR ALL ADHESIVE ANCHORS.
- ACCEPTABLE ADHESIVES ARE HILTI HIT RE 500 V3 OR APPROVED EQUAL. ICBO OR ICC REPORTS SHALL BE SUBMITTED FOR ALL ADHESIVE ANCHOR PRODUCTS.

WELDING

- 1. ALL WELDING SHALL BE PERFORMED BY WELDERS QUALIFIED FOR THE WELD AND POSITION SHOWN IN ACCORDANCE WITH AWS AND HAVING CURRENT CERTIFICATION FROM WABO.
- 2. ALL WELDS SHALL BE PERFORMED WITH PROCEDURES PREQUALIFIED OR QUALIFIED IN ACCORDANCE WITH AWS D1.1 AND D1.4.
- THE WELDS SHOWN ARE FOR THE FINAL CONNECTIONS, FIELD WELD SYMBOLS ARE SHOWN WHERE FIELD WELDS ARE REQUIRED BY THE STRUCTURAL DESIGN. THE CONTRACTOR IS RESPONSIBLE FOR DETERMINING IF A WELD SHOULD BE SHOP — OR FIELD WELDED IN ORDER TO FACILITATE THE STRUCTURAL STEEL ERECTION.
- 4. WELDING ELECTRODES SHALL BE 70 KSI STRENGTH AND SHALL BE "LOW-HYDROGEN" ELECTRODES.

CONCRETE WORK

- 1. ALL CONCRETE WORK SHALL COMPLY WITH REQUIREMENTS OF ACI 301 AND ACI 318, UNLESS NOTED OTHERWISE.
- 2. REINFORCING STEEL
 - A. ALL REINFORCING STEEL SHALL BE DEFORMED STEEL BARS CONFORMING WITH ASTM A 615, GRADE 60, UNO
 - B. LAP REINFORCING BARS PER ACI 318 OR AS SPECIFIED.
 - C. MECHANICAL SPLICES SHALL DEVELOP AT LEAST 125 PERCENT OF THE YIELD STRENGTH OF THE BAR IN TENSION.
 - D. REINFORCING STEEL SHALL BE DETAILED IN ACCORDANCE WITH ACI MANUAL OF STANDARD PRACTICE FOR DETAILING REINFORCED CONCRETE STRUCTURES. ACI 315.
 - E. JOINT DOWEL BARS SHALL BE ASTM A615/A615M G-60, PLAIN STEEL BARS, CUT TRUE TO LENGTH WITH ENDS SQUARE AND FREE OF BURS.
 - F. ALL REINFORCING STEEL SHALL HAVE A 3" CLEAR COVER. UNO.
- 3. ALL FALSEWORK AND FORMWORK CONSTRUCTION WORK SHALL BE COORDINATED AND PERFORMED IN STRICT ACCORDANCE WITH THE PERMIT REQUIREMENTS. THESE DRAWINGS DO NOT INCLUDE ALL REQUIRED PROTECTION MEASURES. MITIGATION MEASURES AND BMPS ASSOCIATED WITH THIS PROJECT.
- 4. FORM TIES SHALL USE WIRE TIES AND WOOD SPACERS.
- 5. FORMS SHALL BE CONSTRUCTED SO AS TO BE RIGID, UNYIELDING, TRUE TO LINE. LEVEL, AND SUFFICIENTLY TIGHT TO PREVENT ESCAPE OF CONCRETE.
- 6. CLEAN FORMS OF ALL WASTE, DEBRIS, OR OTHER OBJECTS AND SUBSTANCES DELETERIOUS TO THE CONCRETE, CONCRETE SURFACE, OR CONCRETE ELEMENT, PRIOR TO CASTING.
- 7. PRIOR TO INSTALLATION OF FORM WORK, FORMS SHALL BE TREATED WITH A RELEASE AGENT, BOND-BREAKER OR PARTING COMPOUND.
- 8. STANDING WATER IN THE FORMS SHALL NOT BE PERMITTED. FORMS SHALL BE CLEAN PRIOR TO PLACING CONCRETE.
- 9. FORMS SHALL REMAIN IN PLACE FOR A MINIMUM OF 7 DAYS, PROVIDED THE AMBIENT TEMPERATURE IS 40 DEGREES FAHRENHEIT OR HIGHER DURING THAT TIME PERIOD. WHEN TEMPERATURES LOWER THAN 40 DEGREES PREVAIL, FORMS SHALL REMAIN IN PLACE LONGER. AT THE ENGINEER'S DIRECTION.
- 10. A MINIMUM CONCRETE COMPRESSIVE STRENGTH AT 28-DAYS SHALL BE:

MAT FOUNDATION: $F'_c = 4500PSI$ WIND SCREEN WALLS: $F'_c = 4000PSI$

11. CONCRETE MIIX SHALL CONFORM TO THE MOST RESTRICTIVE REQUIREMENTS IN ACI 318 TABLE 19.3.2.1 BASED ON THE EXPOSURE CLASSIFICATIONS INDICATED BELOW:

LOCATION	EXPOSURE CLASIFICATION
Al I	F2
	S0
ALL	WO
	C1

- 12. ALL EXPOSED CONCRETE CORNERS SHALL BE CHAMFERED 3/4", UNO...
- 13. SUBMITTALS:
 - A. CERTIFICATES OF SPECIFICATION COMPLIANCE FOR MATERIALS USED.
 - B. PROPOSED CONCRETE DESIGN MIX, INDICATING CONSTITUENT MATERIAL CONTENTS PER CUBIC YARD OF CONCRETE.
 - C. TEST CERTIFICATES FOR COMPRESSIVE STRENGTH, YIELD, AIR CONTENT, AND SLUMP OF THE PROPOSED CONCRETE MIX. AS A MINIMUM, COMPRESSIVE STRENGTH TEST RESULTS AT 7 AND 28 DAYS SHALL BE PROVIDED IN ACCORDANCE WITH ACI 318.
 - D. MANUFACTURER'S NAME AND SPECIFICATIONS AND CERTIFICATES OF COMPLIANCE WITH APPLICABLE STANDARDS SHALL BE PROVIDED FOR ALL ADMIXTURES, CONCRETE BONDING AGENTS, CURING COMPOUNDS, ETC. PROPOSED FOR USE ON THE JOB.
- 14. WHERE CONCRETE IS CAST AGAINST EXISTING CONCRETE, THE EXISTING CONCRETE SHALL BE CLEAN AND FREE OF ANY LOOSE MATERIAL.

SPECIAL INSPECTION

SPECIAL INSPECTION SCHEDULE ESTABLISHED PER 2015 SBC SECTION 110 & CHAPTER 17 CONTINUOUS **PERIODIC** ITEM COMMENTS INSPECTION INSPECTION CONCRETE REINFORCING PLACEMENT PREPARATION OF TEST SPECIMENS CONCRETE PLACEMENT Χ CURING REF. NOTE 8 ADHESIVE ANCHOR PLACEMENT STRUCTURAL STEE FABRICATION & ERECTION SINGLE PASS FILLET WELDS ≤ 5/16" REF. NOTE 4

- THE ITEMS CHECKED WITH AN "X" SHALL BE INSPECTED IN ACCORDANCE WITH SBC CHAPTER 17 BY THE ENGINEER OF RECORD AND A CERTIFIED INSPECTOR FROM AN ESTABLISHED TESTING AGENCY FOR MATERIAL TESTING. THE TESTING AGENCY SHALL SEND COPIES OF ALL STRUCTURAL TESTING AND INSPECTION REPORTS DIRECTLY TO THE ENGINEER. ANY MATERIALS WHICH FAIL TO MEET THE PROJECT SPECIFICATIONS SHALL IMMEDIATELY BE BROUGHT TO THE ATTENTION OF THE ENGINEER. SPECIAL INSPECTION TESTING REQUIREMENTS APPLY EQUALLY TO ALL BIDDER DESIGNED COMPONENTS.
- CONTINUOUS SPECIAL INSPECTION MEANS THAT THE SPECIAL INSPECTOR IS ON THE SITE AT ALL TIMES OBSERVING THE WORK REQUIRING SPECIAL INSPECTION (IBC 1702). PERIODIC SPECIAL INSPECTION MEANS THAT THE SPECIAL INSPECTOR IS ON SITE AT TIME INTERVALS NECESSARY TO CONFIRM THAT ALL WORK REQUIRING SPECIAL INSPECTION IS IN COMPLIANCE.
- INSPECTION REQUIREMENTS FOR SYSTEMS DESIGNED BY OTHERS SHALL BE DEFINED BY THE REGISTERED DESIGN PROFESSIONAL RESPONSIBLE FOR THEIR DESIGN.
- 4. ALL WELDS SHALL BE VISUALLY INSPECTED.

PARTIAL/COMPLETE PENETRATION


PILING

- ALL COMPLETE PENETRATION WELDS SHALL BE TESTED ULTRASONICALLY OR BY USING ANOTHER APPROVED METHOD.
- OWNER WILL EMPLOY AND PAY FOR SPECIAL INSPECTION & TESTING SERVICES TO ENSURE COMPLIANCE WITH THE REQUIREMENTS OF THE CONTRACT DOCUMENTS.
- (4) CONCRETE CYLINDERS SHALL BE COLLECTED FOR EACH POUR MADE. (1) 7-DAY BREAK, (2) 28-DAY, (1) SPARE.
- INSPECTION OF DRILLED CONCRETE ANCHORS, INCLUDING EXPANSION AND ADHESIVE GROUTED ANCHORS, SHALL INCLUDE VISUAL VERIFICATION OF DRILLED HOLE DEPTH, SPACING, EDGE DISTANCES AND HOLE CLEANING. FOR GROUTED ANCHORS, GROUT INSTALLATION SHALL BE OBSERVED AND GROUT PRODUCT SPECIFICATION AND PREPARATION SHALL BE VERIFIED.

EARTHWORK

1. STRUCTURAL FILL SHALL BE IN ACCORDANCE WITH THE PANGEO REPORT DATED 8/17/2020.

Tacoma, Washington 98407 (253) 396-0150 Fax (253) 396-0162

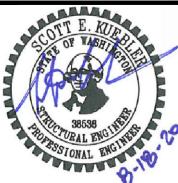

KUP	NO.	DATE	BY	REVISION
8				
ENGINEER OF				
8.10				

SEATTLE IRON AND METALS DUST CONTROL IMPROVEMENTS


STRUCTURAL NOTES

SHEET NO.	07 OF 13
DRAWING NO.	S1.0
CHECKED: IDF	DATE: 8/10/2020
DESIGN: KCP	SCALE: AS SHOWN
DRAWN: TRL	PROJECT NO.: 190019

REF. NOTE 5

ENGINEER

BY GEOTECHNICAL

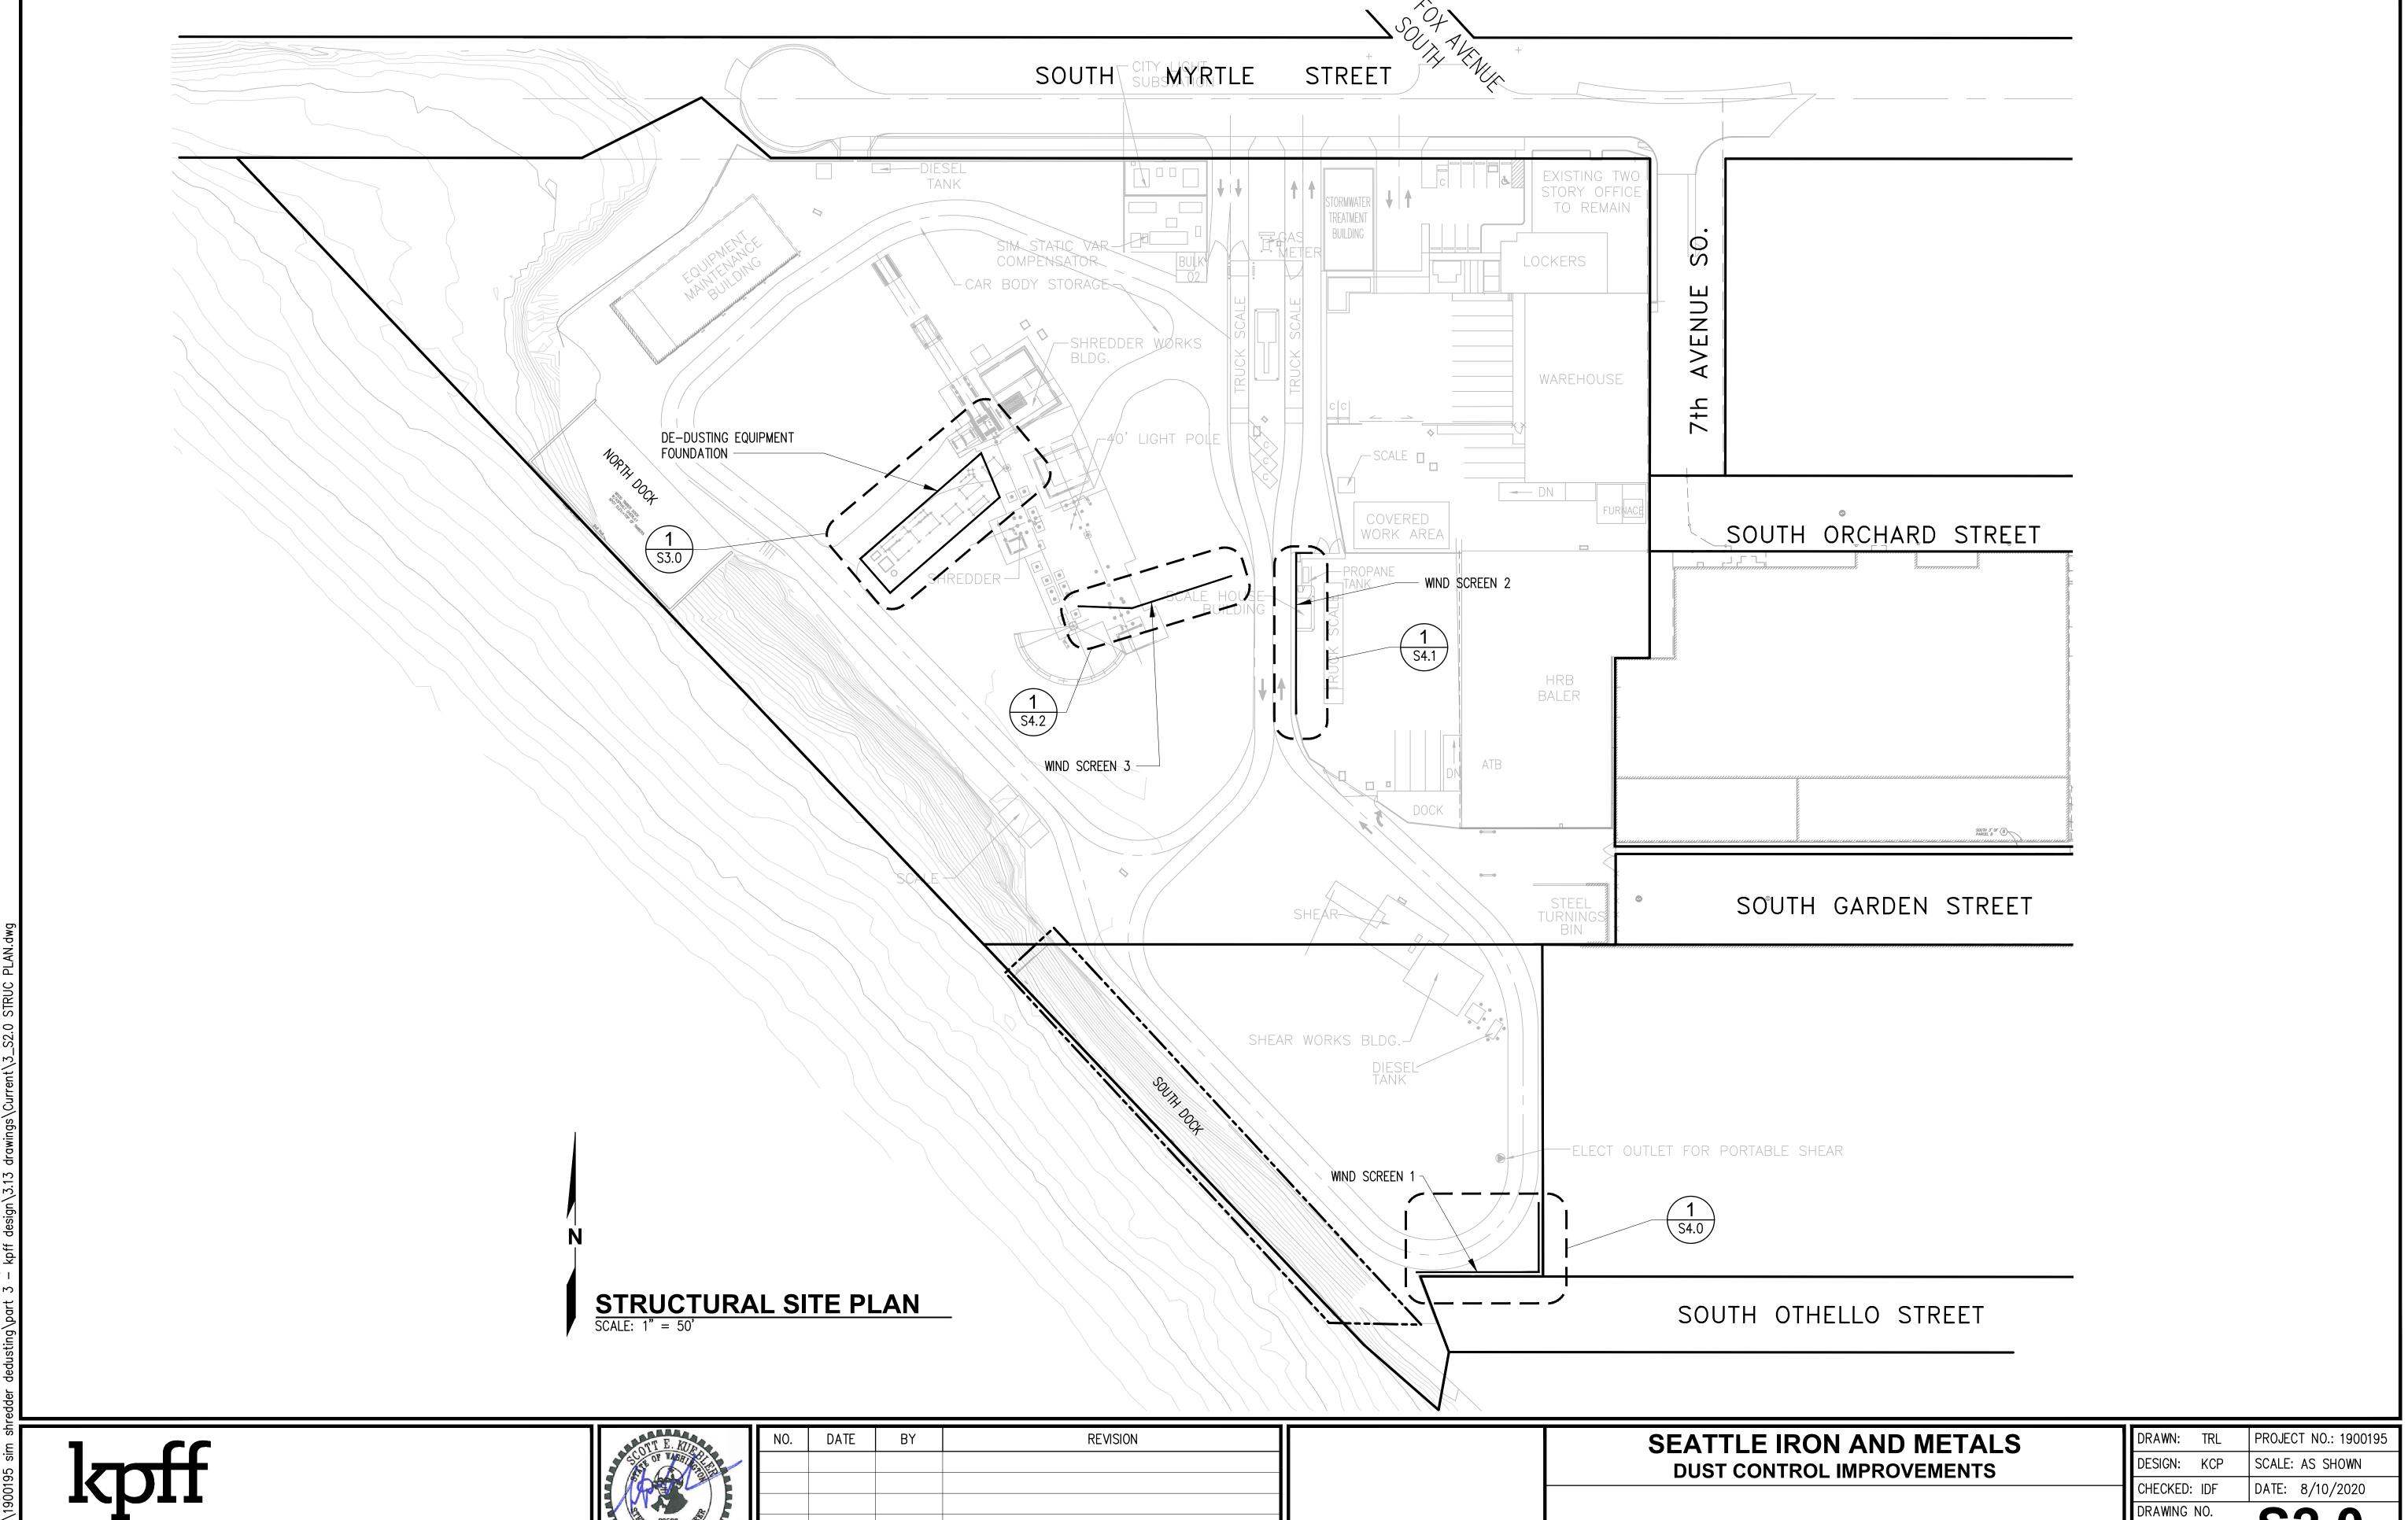


STRUCTURAL SITE PLAN

08 of **13**

SHEET NO.

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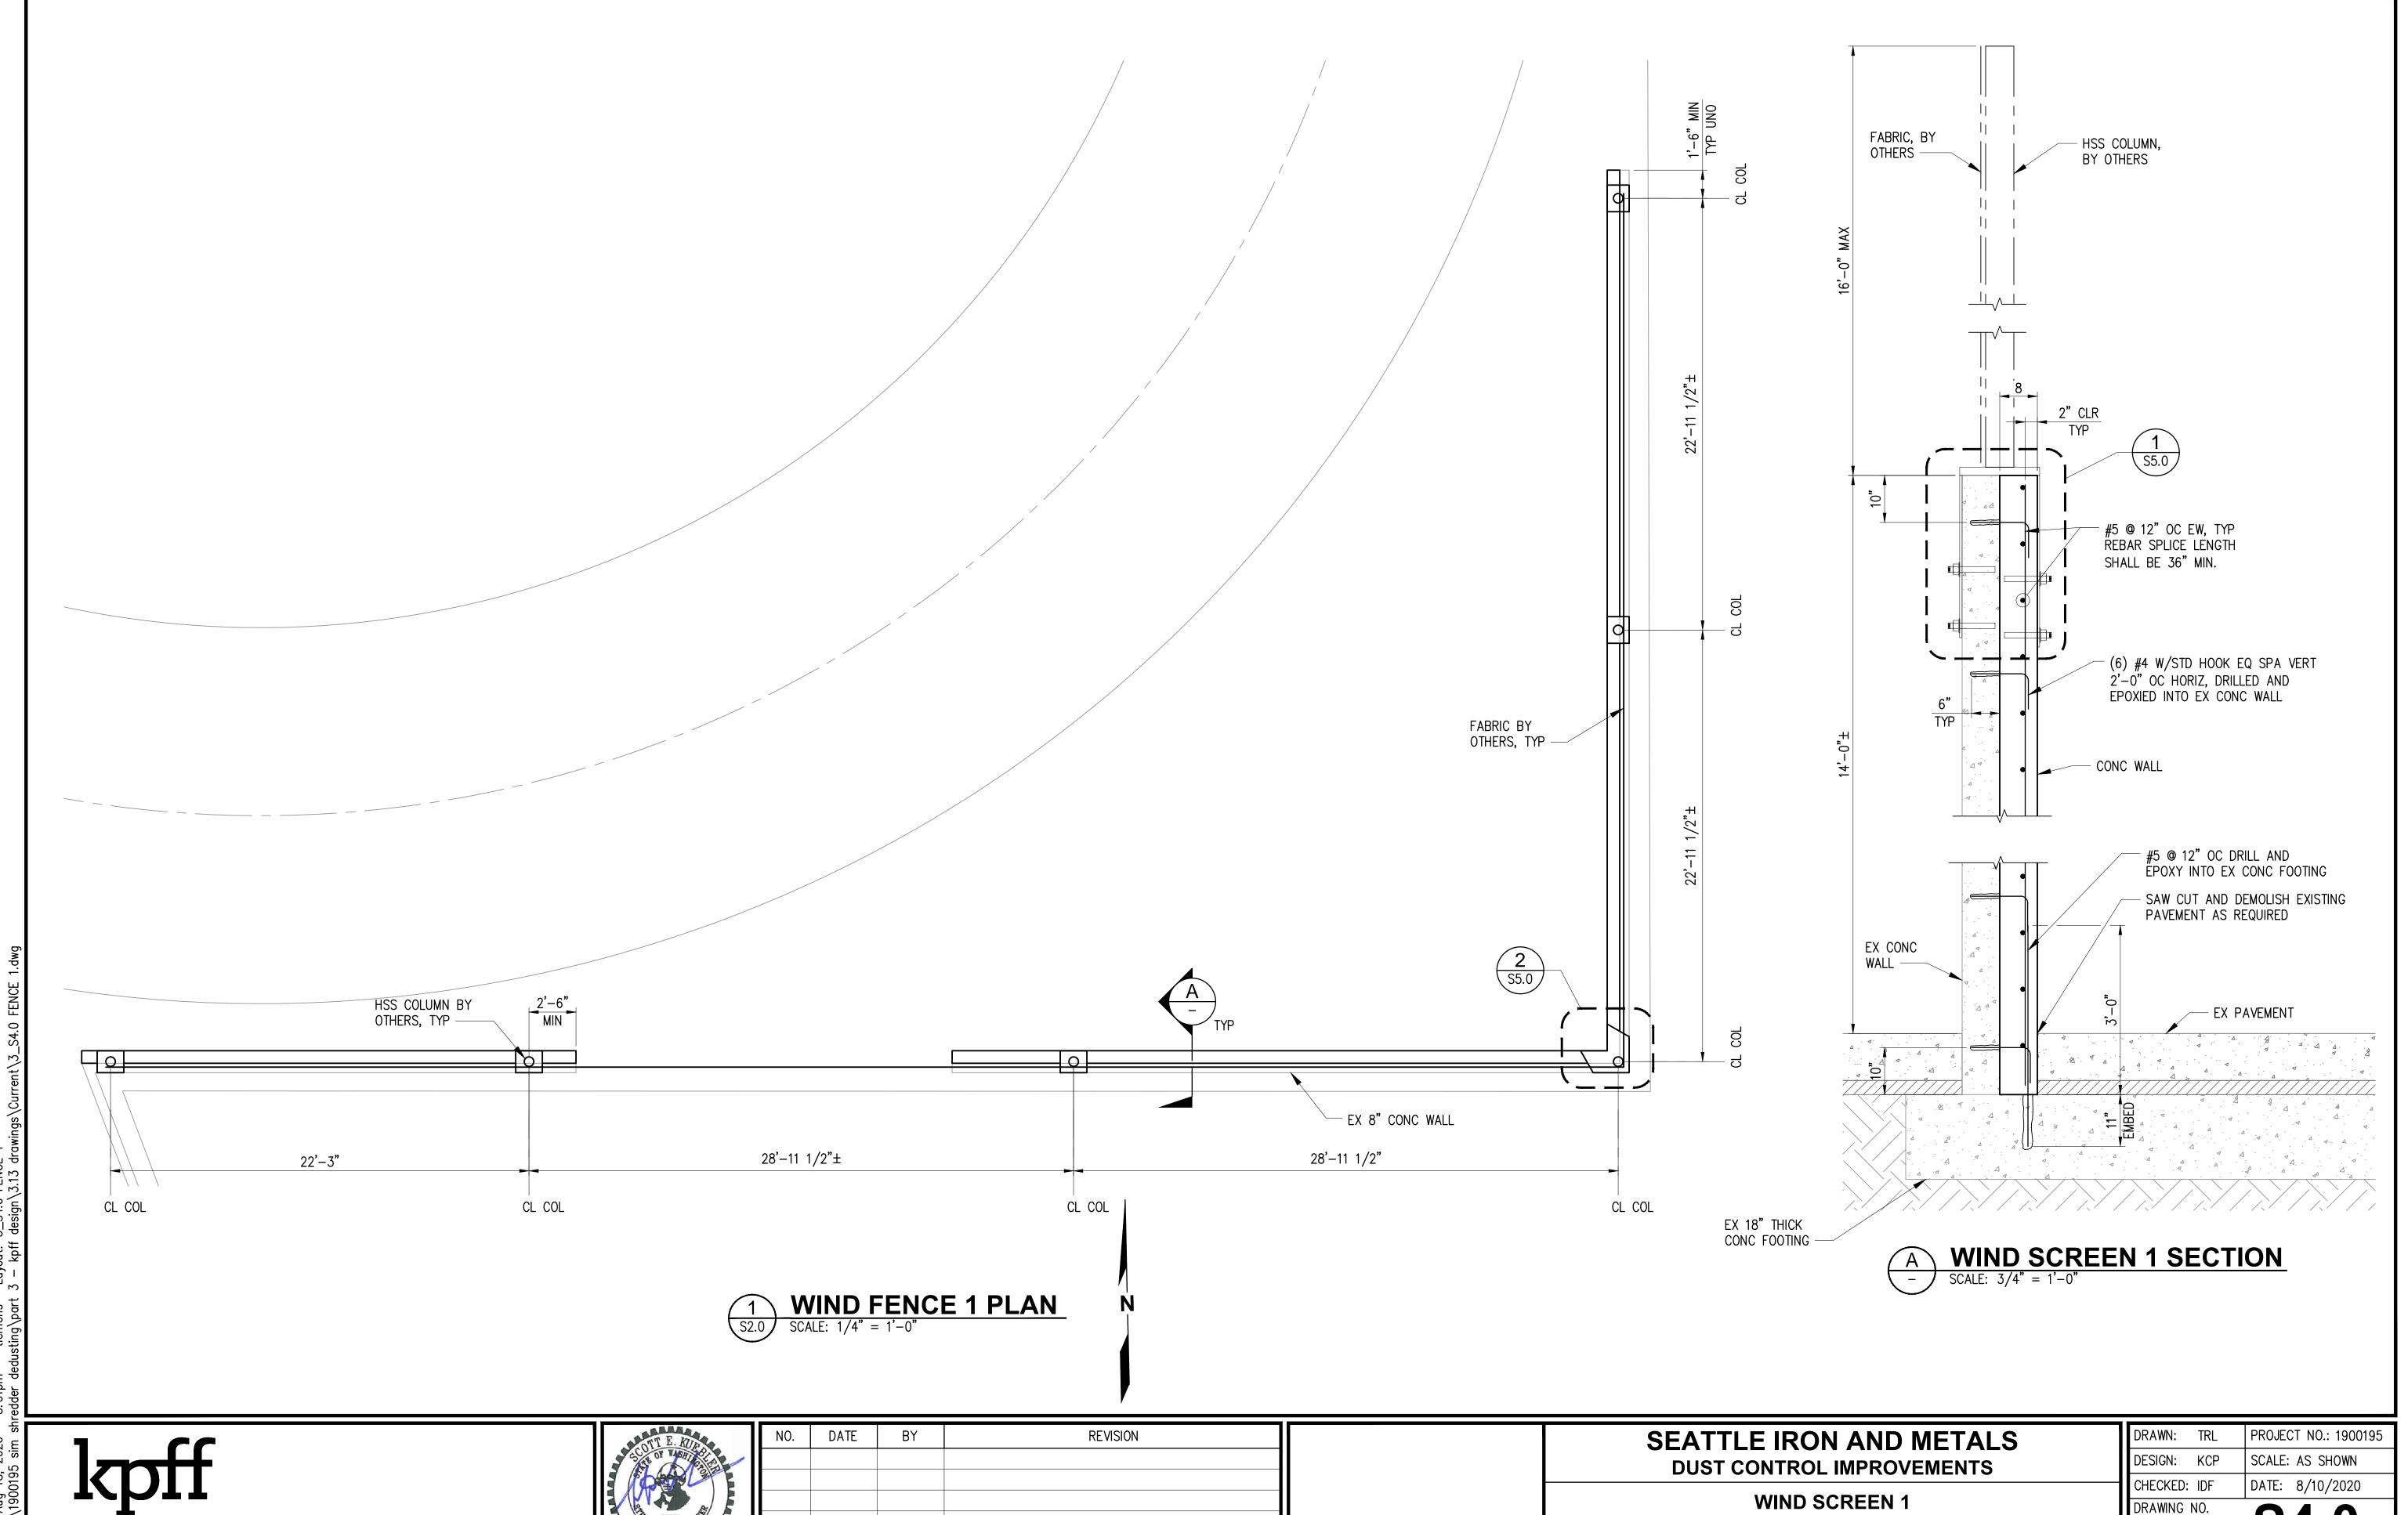


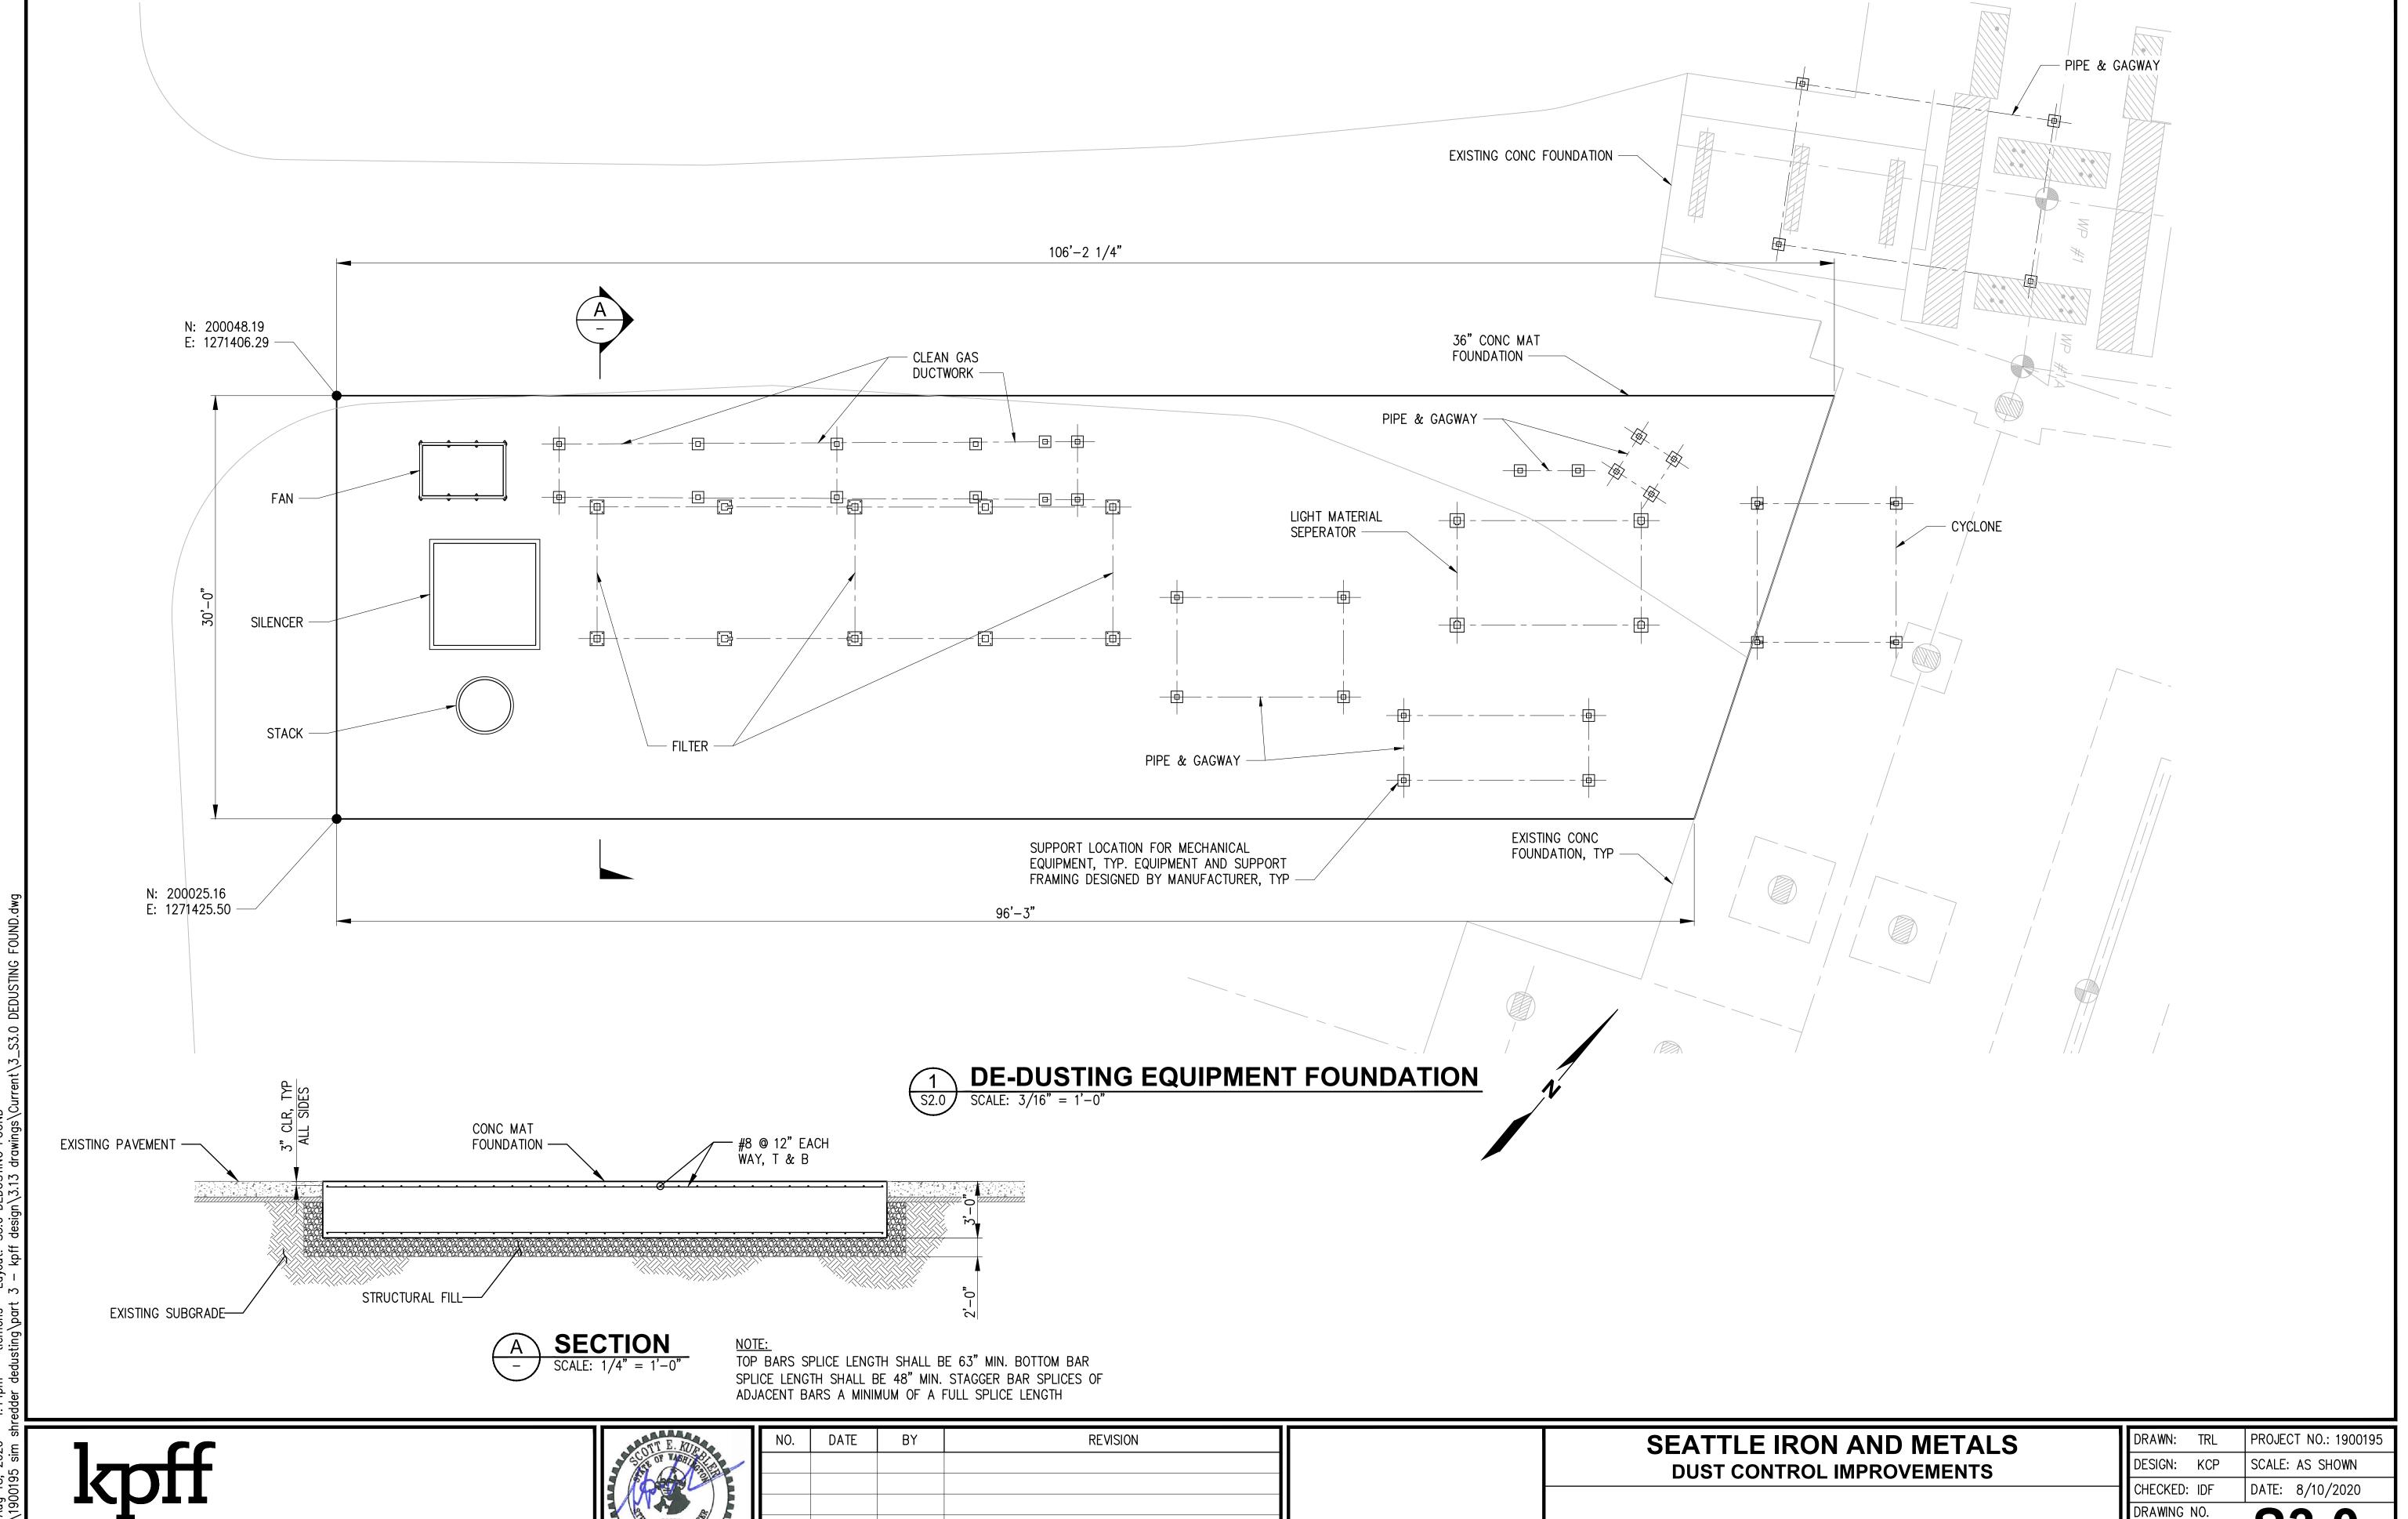DE-DUSTING EQUIPMENT FOUNDATION

09 OF **13**

SHEET NO.

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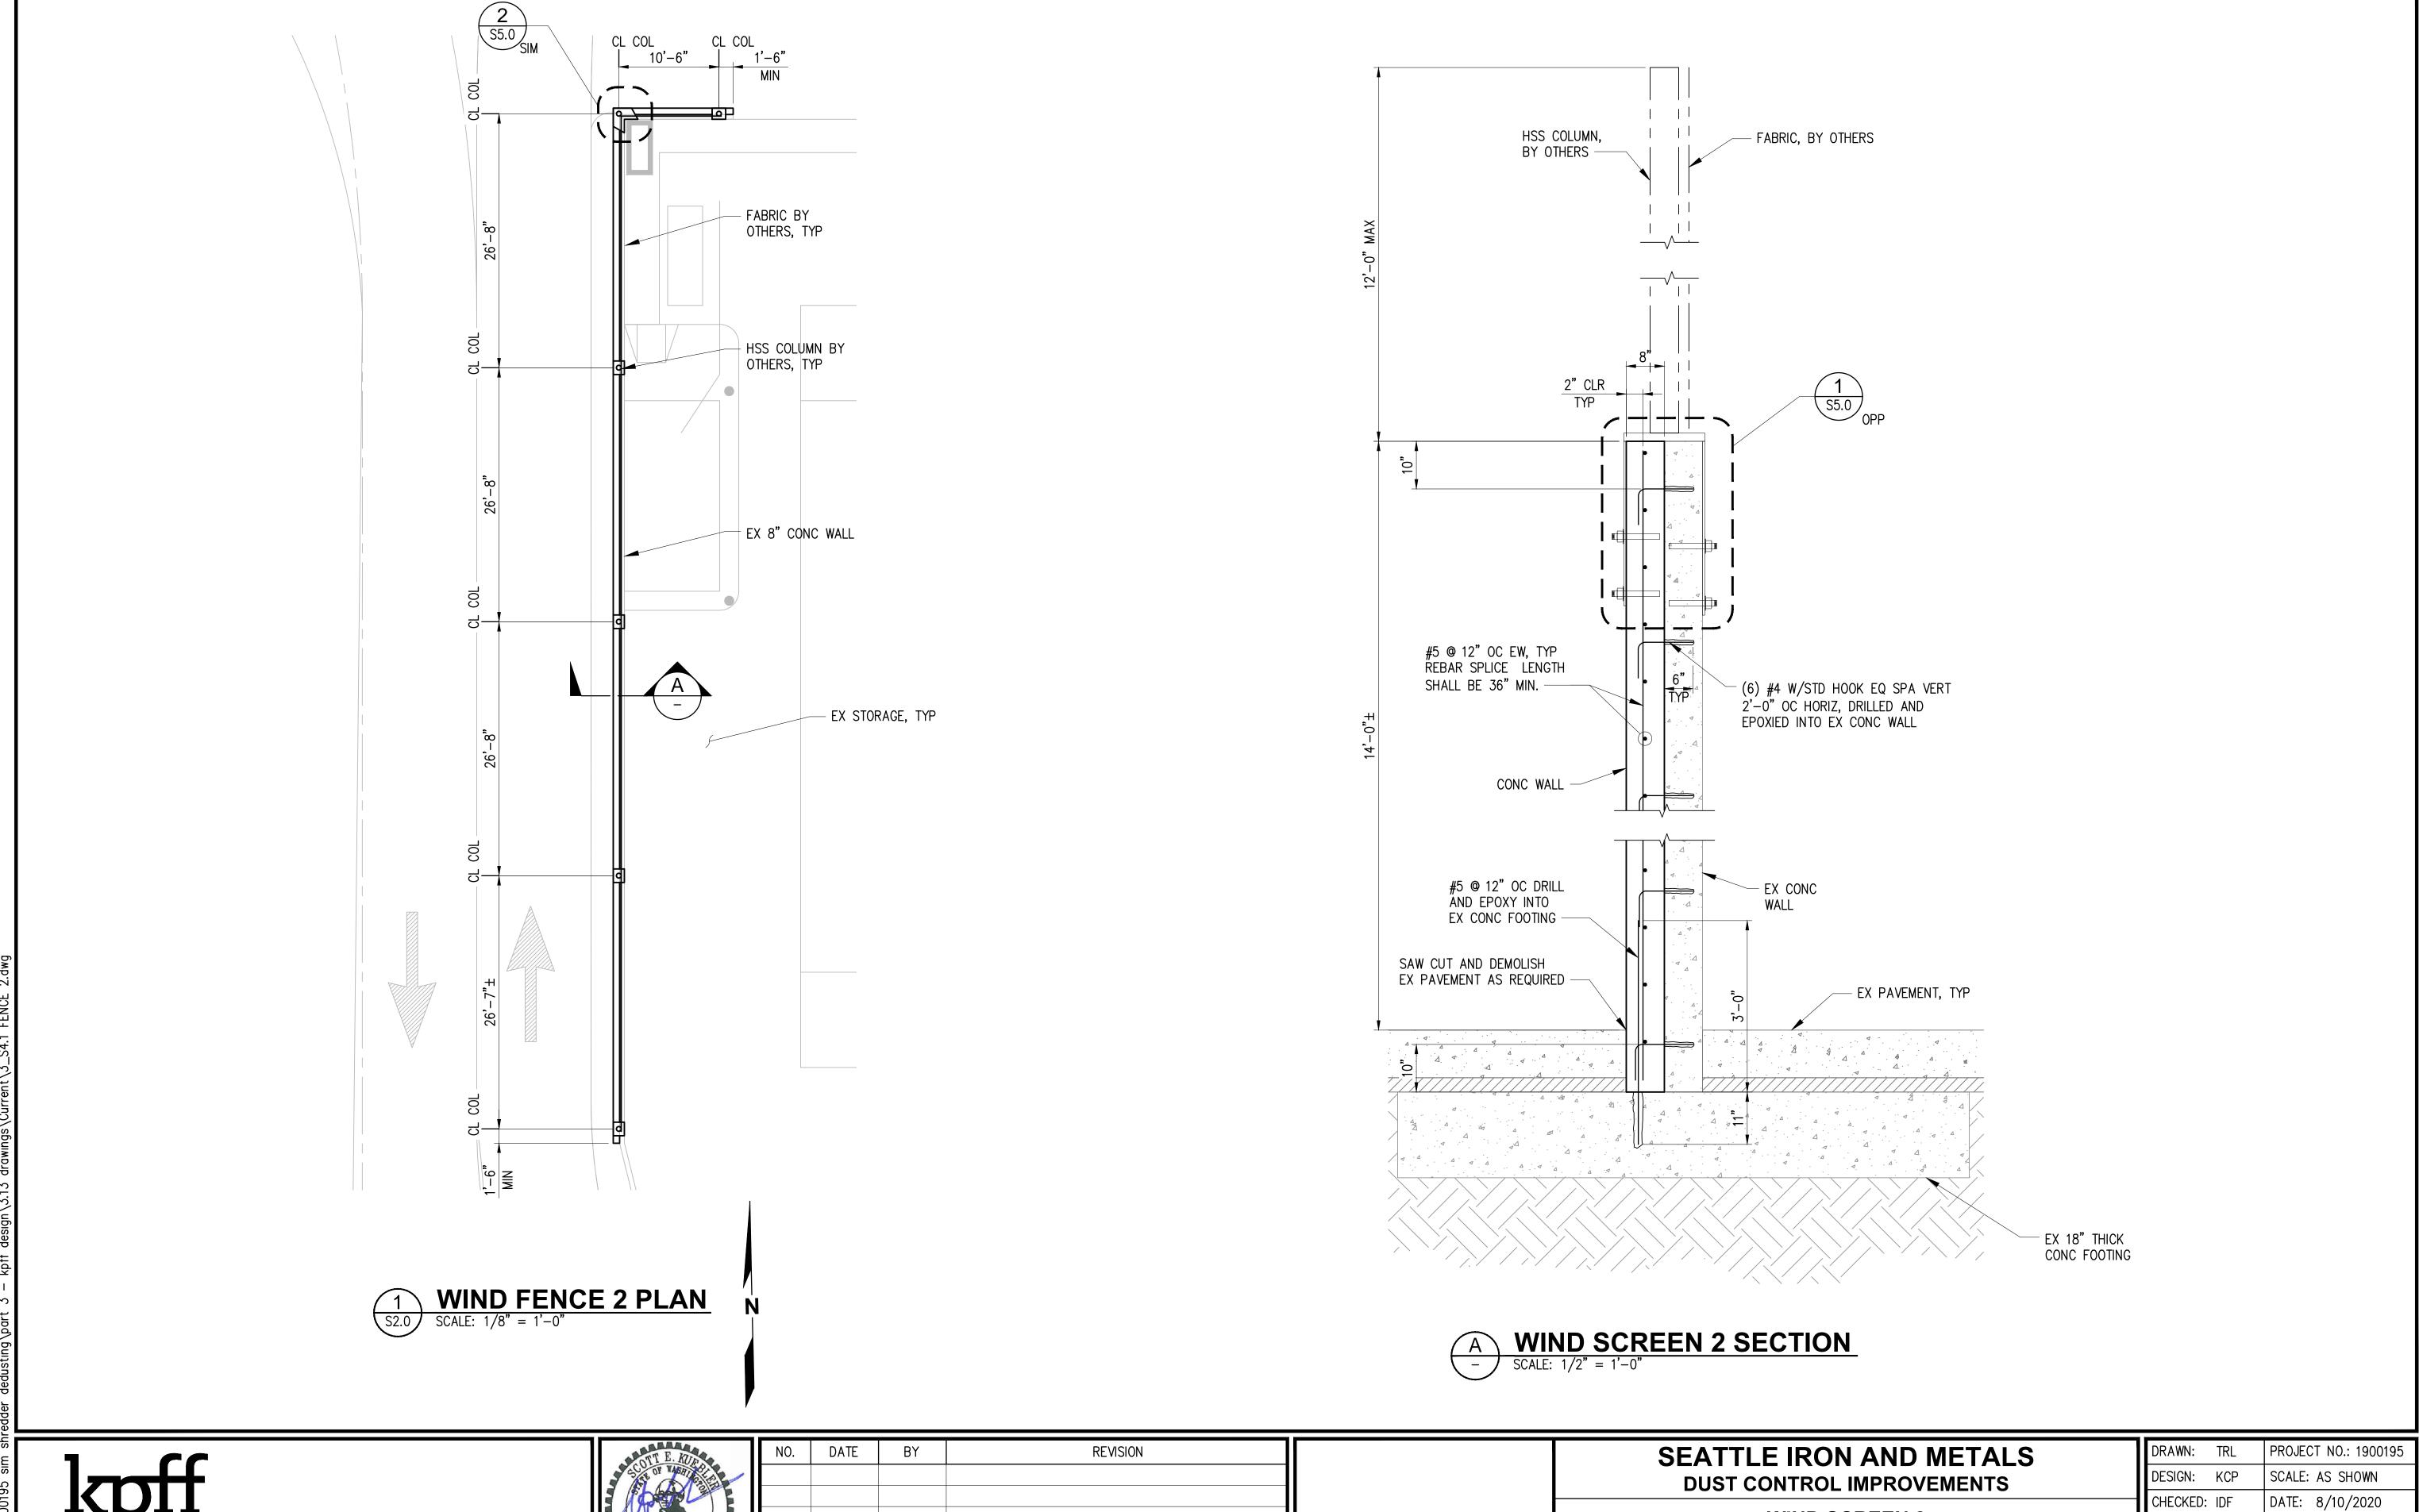


PLAN AND SECTION

10 OF **13**

SHEET NO.

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WIND SCREEN 2


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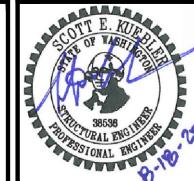
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11 OF **13**

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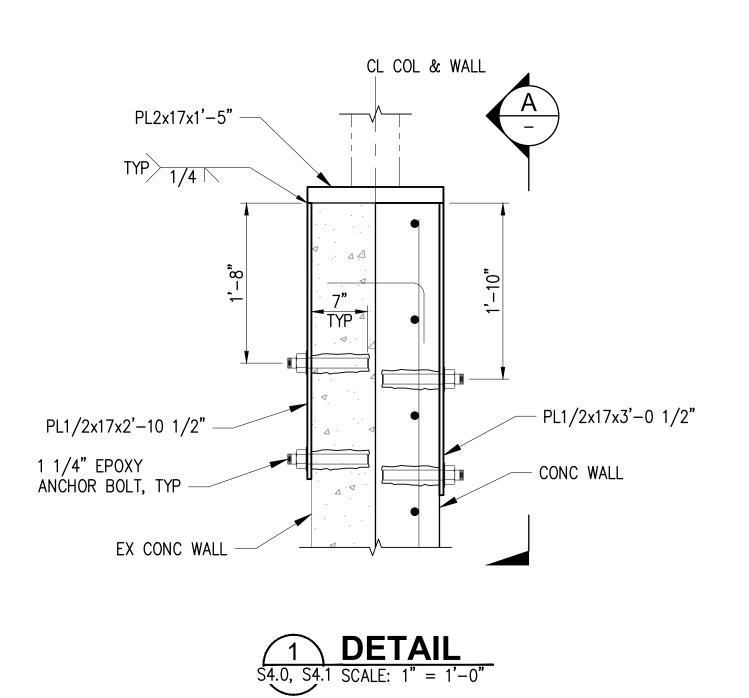
Tacoma, Washington 98407 (253) 396-0150 Fax (253) 396-0162





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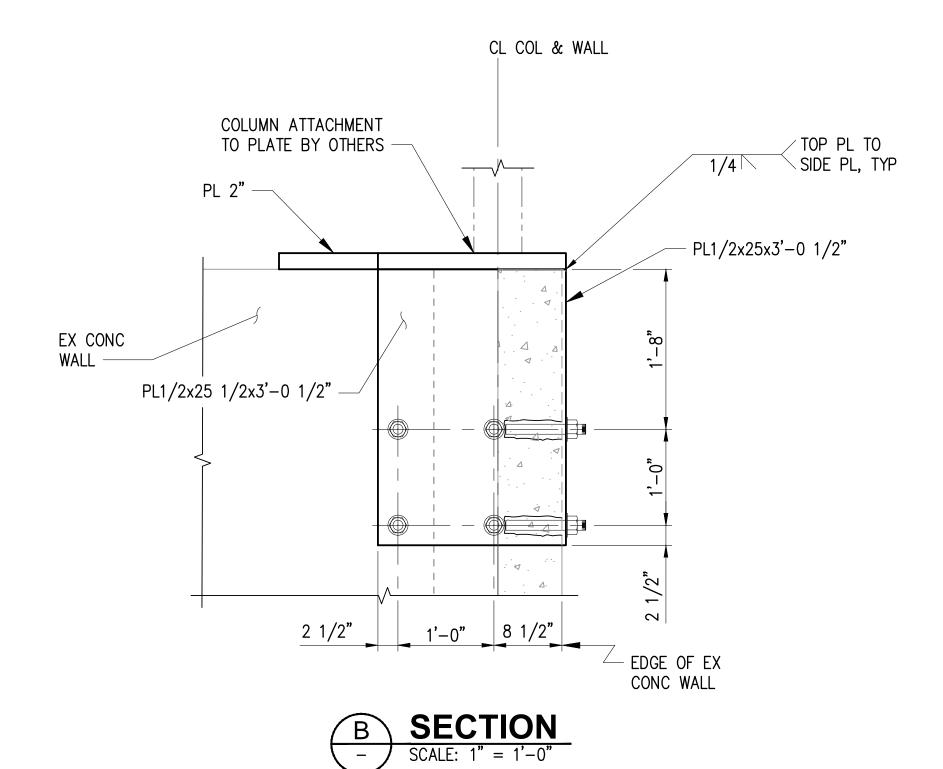
PLAN AND SECTION


SHEET NO.	12 OF 13
DRAWING NO.	S4.2
CHECKED: IDF	DATE: 8/10/2020
DESIGN: KCP	SCALE: AS SHOWN
DRAWN: TRL	PROJECT NO.: 1900195

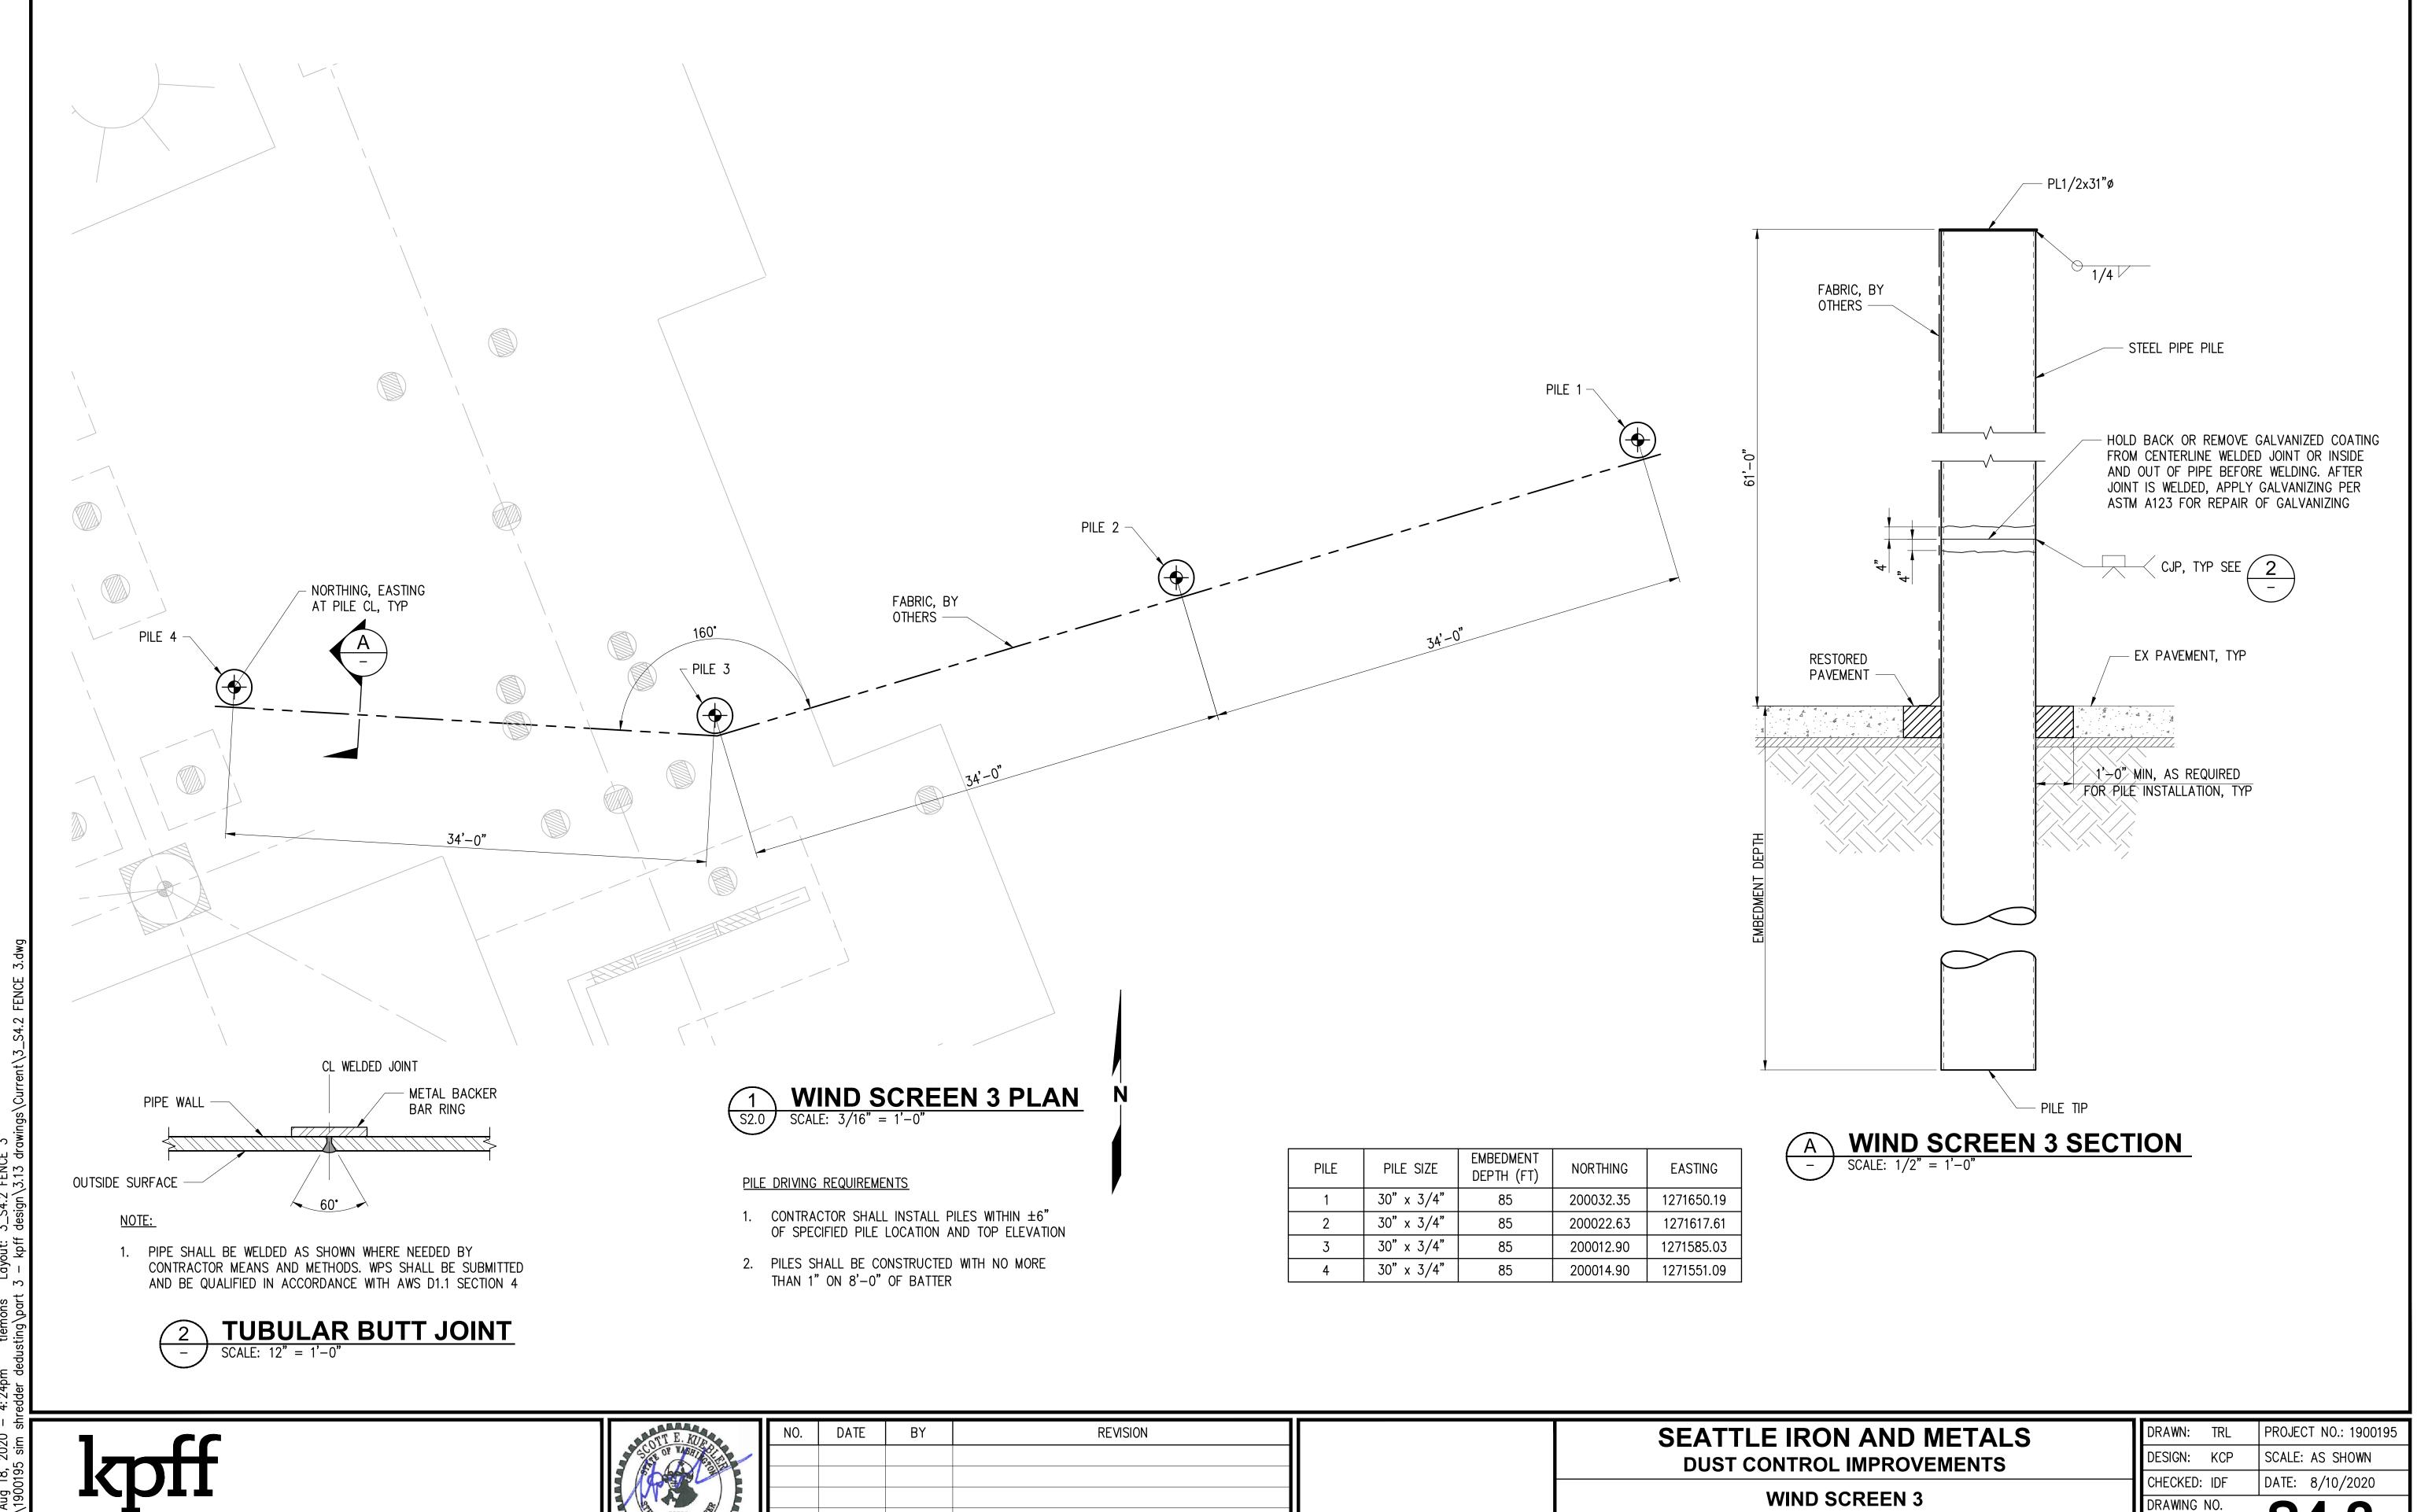



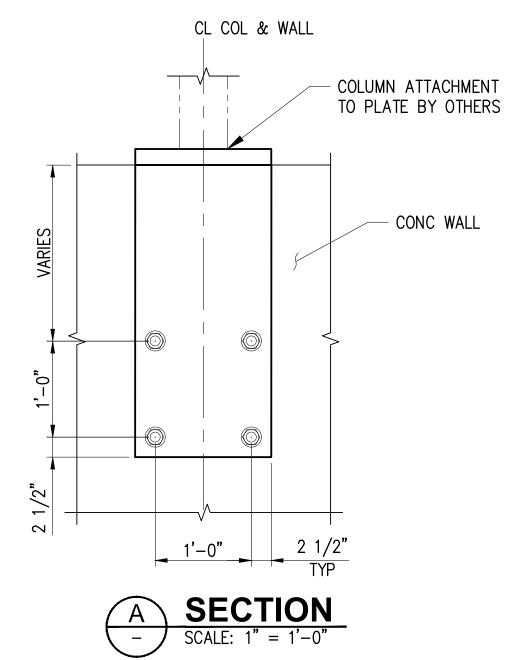

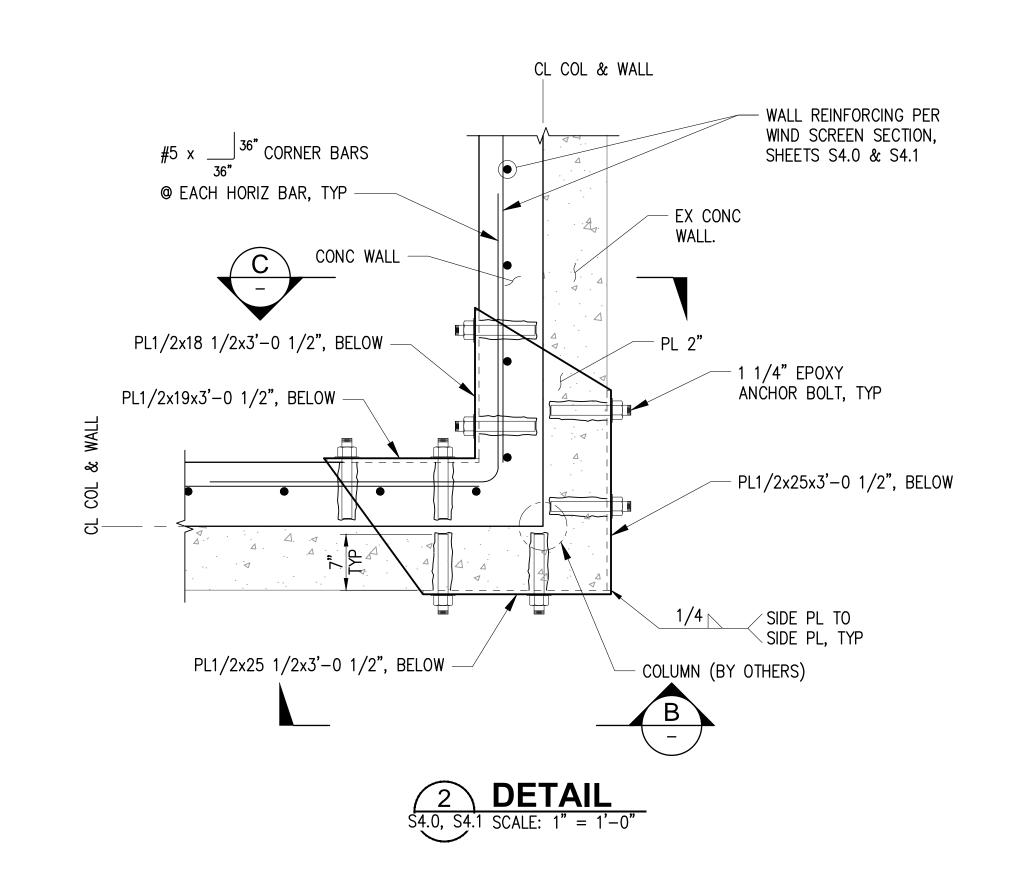

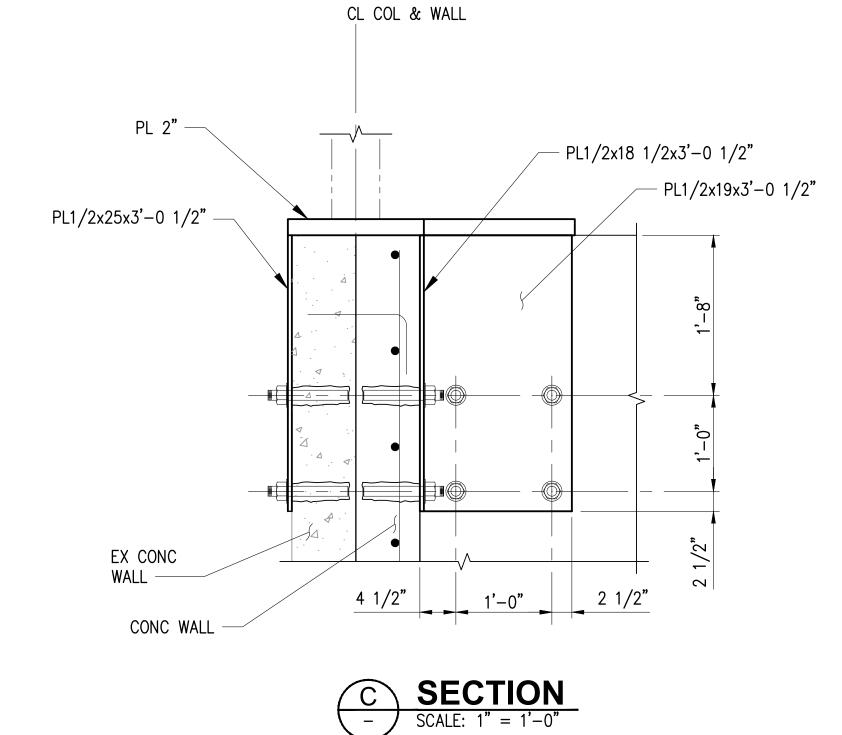

2407 North 31st Street, Suite 100 Tacoma, Washington 98407 (253) 396-0150 Fax (253) 396-0162



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SEATTLE IRON AND METALS DUST CONTROL IMPROVEMENTS

STRUCTURAL DETAIL	(

DRAWN: TRL	PROJECT NO.: 1900195
DESIGN: KCP	SCALE: AS SHOWN
CHECKED: IDF	DATE: 8/10/2020
DRAWING NO.	S5.0
SHEET NO.	13 OF 13

Attachment B



August 14, 2020

RE: Puget Sound Keeper Alliance v. Seattle Iron & Metals Corporation

To Whom It May Concern,

This letter is intended to provide assurance that I have received and reviewed the Consent Decree (and amendment) between Puget Sound Keeper Alliance v. Seattle Iron & Metals Corporation and that I am authorized on behalf of Just Health Action (JHA) to make the following binding commitments on behalf of the *Duwamish Valley Clean Air Program* run by Duwamish River Cleanup Coalition (DRCC) and JHA:

- 1. I understand that JHA will receive funds from Seattle Iron & Metals as specified in the Consent Decree.
- 2. JHA will use these funds for the *Duwamish Valley Clean Air Program*.
- 3. JHA will not use any money it receives under the Consent Decree for lobbying purposes.

Air pollution is a top community health priority in the Duwamish Valley. The community has the highest childhood asthma hospitalization rates in the City of Seattle and a 13 year difference in life expectancy compared to wealthier parts of Seattle. DRCC has resurrected an air quality program that was originally an EPA Environmental Justice Collaborative Problem Solving Grant from 2014-2016. In order to improve the health of Duwamish Valley residents, the *Duwamish Valley Clean Air Program* goals are to: 1. Reduce air pollution (indoor and outdoor); 2. Engage interested partners/collaborators; 3. Build community capacity; and 4. Develop an evaluation method to measure success. We will use the funds to:

- Strategize on our *Clean Air* approach;
- Develop agendas;
- Develop meeting materials and presenting at meetings;
- Analyze meeting materials;
- Work on health related issues and communicating with relevant partners;
- Collect updated information on health disparities (e.g. asthma);
- Work with a few partners on developing a quantitative and qualitative evaluation to measure success; and
- Implement recommendations made by project partners.

JHA is a Seattle-based, not for profit organization (Tax ID 26-3032913) which advocates for reducing health inequities that result from social, economic, environmental, and political conditions. Through a social justice lens, we research and document health inequities and we lead interactive workshops to engage diverse groups to build skills towards systems level change. JHA is committed to sound fiscal management of this project.

Please do not hesitate to contact me with questions or for additional information.

Sincerely,

C. Linn Gould, MS, MPH

Executive Director

Attachment C

City of Seattle
Department of Construction and Inspections (Seattle DCI)
PLAN COVERSHEET

Updated
Official

INSTRUCTIONS: Complete all areas of sections 1 - 7 that pertain to your project. Please note that sections 8 - 14 are to be completed by Seattle DCI staff.

Fire alarm 12. SHOP DRAWINGS, KEY AREA INSPECTION & BUILDING CONDITIONS (Seattle DCI staff use only) 11. ENVIRONMENTALLY CRITICAL AREAS INFO (Seattle DCI staff use only) DATE RECEIVED AT INTAKE NOTE: A separate side sewer permit is required from Seatte DCI for ALL new drainage and sewer installations. For more information, call ti Sewer and Drahage Review Desk at (206) 684-5362 or sides ewerinfo@seattle.gov. 10. DRAINAGE & SEWER REVIEW (Seattle DCI staff use only) 14. DEPARTMENT SIGN OFFS (Seattle DCI staff use only) 13. PERMIT ISSUANCE AUTHORIZATION (Seattle DCI staff use only) Date Sq. ft Sq. ft Total SEATTLE DCI SEWER AND DRAINAGE REVIEW DESK: (206) 684-5362 or sides MECHANICAL PLANS EXAMINER NFPA 13 NFPA 13 R Partial system Location NOTE: The drainage system shown in these plans may be changed Permit # DATE 10/31/92) | X Site is not located in ECA | Aspect coverage this permit (sq. ft.) SIDE SEWER REVIEW REQUIRED? Denied Granted Type DRAINAGE REVIEW REQUIRED? STREET IMPROVEMENT (SDOT) BUILDING PLANS EXAMINER CONVEYANCE/ELEVATOR Sprinkler drawings required for: Required shop drawing key area inspections: HEALTH (King County) SHORING (SDOT) ZONING (ind. s
CURB CUT
ORDINANCE
STRUCTURAL
ENERGY
MECHANICAL
DRAINAGE GRADING 8. LAND USE CONDITIONS (Seattle DCI staff use only) 9. SPECIAL INSPECTIONS (Seattle DCI staff use only) 1 planner Target performance path (TPP) SEC C402.1.5 i, please stamp "for reference only", CODE USED FOR DESIGN (select one) X 2015 Seattle Building Code
2015 Seattle Residential Code
2015 SBC (struct) and 2015 SRC (a PRIORTY GREEN FACILITATED Screening required prior to building permit or MUP intake appointment. ☐ Yes 区 No ☐ Emergen Target Performance Path Compliance Method (www.seattle.gov/sdci/prioritygreen)
Prior approval to participate in Priority Green is required. The following does not establish Priority Green status. Priority Green Building Matrix - 10 points
Living Building Challenge
Built Green 5 Star + 2030 Challenge
LEED Platinum + 2030 Challenge Multi-family 4+ stories 🔀 Non-residential ocation N/A EMERGENCY SYSTEMS PROVDED

Exit and pathway lighting Stainway pressurization Stocke removal system Other: Energy Credit (Table R406.2) Option: Substantial alteration (SBC CH 34) (If mechanical drawings are included with plans ce (TBP) Simulated performance alternative 5. BUILDING CODE INFORMATION 6. ENERGY/MECHANICAL CODE ☐ Exterior wall Type Commercial kitchen hood exhaust system | Furne hood | Spray paint booth | Other RESIDENTIAL BUILDINGS (Single family, duplex, bowrhouse, and multi-family 3 stories or less) Mechanical System Value\$ by unit) Non-residential cooling and heating load (for Stuctural load calculation (for moderneal equipm COMMERCIAL BUILDINGS (Non-residential, R1 lodging, and Multi-family four stories and greate 7. PRIORITY GREEN (see building data sheet) Proposed # of above-grade stories N/A Proposed # of below-grade stories N/A Rooftop MULTIPLE BUILDINGS IN THIS PROJECT?

Thes FOR Lives, life out departs sheets and attach. Shown on plann sheet.

IN A PROVIDE THIS INFORMATION FOR EVERY BUILDING IN YOUR PROJECT. Sprinkers NFPA 13 NFPA 13 R Partial system Fire alarm OTHER MECHANICAL EQUIPMENT INCLUDED IN THIS APPLICATION Multi-family 1-3 stories nance UA/SHGCA/VTA HEATED ☐ Alteration HVAC mechanical system is <u>NOT</u> included with this application

HVAC mechanical system <u>IS</u> included with this application PRIORTY GREEN EXPEDITED Screening required prior to building permit intake appointment. ☐ Noise ∞ Total UA alternative Maximum Size: Cold
Pathum
Seatle DGI Alternative Path for Single Family ION OF DUCTWORK OR MECHANICAL EQU Interior Exterior ground mounted
MECHANICAL-ONLY PERMIT
Related building permit project # Using 3.5 credits for SEC Table 9-1 Addition **№** | Residential equipment sizing calc (unit | Target UA/SHGCA/VTA Calculation | TBP or TPP Report GENERAL PROJECT INFORMATION Existing # of above-grade stories N/A BUILDING ENVELOPE COMPLIANCE Single-family/duplex/townhouse New Ervelope SCOPE OF MECHANICAL WORK _ ≺es Existing Envelope - no changeExisting Envelope - altered =xisting # of below-grade stories SCOPE OF CONSTRUCTION DOCUMENTS INCLUDED COMPLIANCE PATH: Prescriptive
Heating Equipment:
Minimum Size: | 4 star | 5 star LEED cupancy DCI building ID SEC C 402.1 FLOOR LEVEL □ New cor 1601 5th Ave, Seattle, ¥ ջ |<u>X</u> Waste Diversion Report to be submitted to SPU - Projects > 750 square feet must submit a Waste Diversion Report to SPU within 60 days of DCI project final important approach formation and submitted document the public document the public document with a seat the govintif Forbusines sea "Gonstruction CDWasteldan against of Recycling equirement Missachives independent than the against and against an expectation of the public pu Mater Service Inspection by SPU Required.

When the Service Inspection by SPU Required.

Security of the Security of the Security of Security of Security of Security (205) 584-580. To wait expect plants to the Security of Construction of a steel braced fame to support netting that will be designed by others, including attachment, b disrupt wind flow which disperses dust. The braced frame is an independent structure supported on micropiles. PROJECT # 6745050 80. FT | 87.111 | 28.96| NUMBER OF DWELLING UNITS

Existing 3# water Control and Soil Amendment Stands JACKIE.CELIN@KPI Exempt Requires review 1601 5th Ave, Suite 1600, Seattle, WA 98101 601 MYRTLE STRETT, SEATTLE, WA 98134 Bite Impection Required Prior to First Ground Disturbance - Call [208] 684-8800 A e-carlie. DCL state into exterior prior to any ground disturbance related to this permit, including clearing, gribbing or grading, Perconstruction Contennosa, When Required - Call (200 (844-889)

1. When any Special impediors are infantiated in the arbeit of perior to againing work. A conference is required for the bllowing type

1. When any special impediors are infantiated on the plan

when interpreted impediors are infantiated on the plan

1. When interpreted to Chiese sammer special experies on plans unusual or complex inspection or occupancy requirements

3. When is Seleted OC plans sammer species on plans unusual or complex inspection or occupancy requirements Maximum height under the laws of the State of Washington, that the above information is true and correct. Unit(s) occupied by residential tenant

Do not know

Refer to property owner/tenant assista If yes, please provide: DESIGN REVIEW? ALANS@SEAIRON.COM DEFINITION: Housing unit means any dwelling unit, housekeeping unit, guest room, domitlory, or single room occupan unit in a commercial building, an artist's studio dwelling unit, or a liverwork unit. 2. LAND USE CODE INFORMATION CHECK ONLY ONE BOX BELOW TO INDICATE HOUSING OCCUPANCY AT DATE OF PERMIT APPLICATION 3. HOUSING UNIT OCCUPANCY 1. APPLICANT INFORMATION E-MAIL 4. GROUND DISTURBANCE Excavation - cubic yards 16 Required SDOT Permits and Impections
Protection and/or painting/unrowed of street tease requires Seatte Department of Transportation
construction:
Sexpel Emily Zone, (200) 844-593
Sined Use Permits Call prior to construction (200) 844-593 **CUSTOMER ALERT!** GREATER DUWAMISH (MANUFACTURING INDUSTRIAL) Jacqueline Celin/Applicant Fill - cubic yards DEPARTMENT OF NEIGHBORHOODS CERTIFICATE OF APPROVAL REQUIRED? STREET/ALLEY IMPROVEMENTS OR WORK IN THE RIGHT OF WAY REQUIRED? Address and/or permit # osion control is required PRIOR to any ground disturbance. Please refer to Cons Rules for Ufer Grounds - Call (206) 864-5383 If you have any questions or concerns regarding the rules (2005 NEC) for installation Monday - Friday, 7:00 a.m. to 4:30 p.m. ADDRESS ADDRESS E-MAIL N/A

Exempt Requires Shoreline review 701 SOUTH ORCHARD STREET ASSESSOR'S PARCEL NO. **SQ. FT**. 87,117 28,966 on property not affected by permit scope FAX X Yes No ¥, Utside City of Seattle Unit(s) unoccupied
Unit occupied by property owner ☐ Inside City of Seattle CONTACT PERSON Jackie Celin STORIC OR LANDMARK DISTRICT X No units on property Shalmar 08, LLC (206) 682-0040 206-622-5822 PREVIOUS RELATED MUPs SROUND DISTURBANCE DESCRIPTION OF WORK PROJECT ADDRESS ONE IG1 U/85 PARKING SPACES /ERLAY ZONING DISPOSAL SITE ORELINE ZONE SALVAGE YARD PHONE OWNER

UNLESS NOTED OTHERWISE

WITH WIDE FLANGE WELDED HEADED STUD

PILES

SUBMITTAL SHTS PROJECT NO :: VALUE

SCALE: AS SHOWN

 \mathbb{F}

DRAWN:

DESIGN CRITERIA

REINFORCED CONCRETE

1. REINFORCING STEEL

DEAD LOADS

SELF WEIGHT OF ALL MATERIALS

SEISMIC LOADS.
PIPE BRIDGE SEISMIC FORCE RESISTING SYSTEM IS ORDINARY MOMENT FRAME AND ORDINARY CONCENTRICALLY BRACED FRAME.
SERVICE ISLAND PIPE RACK SEISMIC FORCE RESISTING SYSTEM IS SPECIAL CANTILEVER COLUMN SYSTEM.
SITE CLASS D.
RISK CATEGORY II.
SEISMIC DESIGN CATEGORY D.

= 1.517g = 0.582g = 1.012g = 0.082g

 $\overset{\mathsf{A}}{\mathsf{A}}\overset{\mathsf{A}}{\mathsf{A}}$ EXPOSURE CATEGORY C V = 100 mph Kzt = 1.0WIND LOADS:

G

1.09

 $\parallel \parallel$

GENERAL

THESE NOTES CONTAIN GENERAL INFORMATION AND ARE NOT COMPLETE FOR CONSTRUCTION PURPOSES. CONTRACTOR SHALL VERIFY INFORMATION GIVEN HERE , OTHER DOCUMENTS AND BRING ANY CONFLICTS TO THE ATTENTION OF SIM BEFORE BEGINNING AFFECTED WORK. THE ENGINEER WILL RESOLVE ANY SUCH CONFLICT.

ALL DIMENSIONS AND DETAILS WILL BE VERIFIED BY THE CONTRACTOR PRIOR FABRICATION AND CONSTRUCTION.

ALL SHOP DRAWNGS FOR PRECAST CONCRETE ELEMENTS, REINFORCING STEEL, AND MISCELLANEOUS STEEL, SHALL BE SUBMITTED TO AND REVIEWED BY THE ENGINEER PRIOR TO FABRICATION.

CODES AND STANDARDS

- 1. STRUCTURAL
- 2015 A. ALL METHODS AND MATERIALS SHALL CONFORM TO THE SEATTLE BUILDING CODE, EDITION.
- REINFORCED CONCRETE WORK SHALL CONFORM TO THE REQUIREMENTS OF ACI 301-10 "SPECIFICATIONS FOR STRUCTURAL CONCRETE" AND ACI 318-14 "BUILDING CODE REQUIREMENTS FOR STRUCTURAL CONCRETE".

ë

STRUCTURAL AND MISCELLANEOUS STEEL FABRICATION AND ERECTION SHALL CONFORM TO THE AISC "CODE OF STANDARD PRACTICE FOR STEEL BUILDINGS AND BRIDGES" 2010.

ن

AWS ¥ WELDING OF STRUCTURAL AND MISCELLANEOUS STEEL SHALL CONFORM TO D1.1, 2010.

Ö.

E. WELDING OF REINFORCING STEEL SHALL CONFORM TO THE AWS D1.4, 2010.

STRUCTURAL STEEI

- ALL MISCELLANEOUS STEEL SHAPES AND PLATES, EXCEPT AS NOTED BELOW, SHALL CONFORM TO ASTM A 572, GRADE 50.
- ALL HSS SHAPES SHALL CONFORM TO ASTM A500, GRADE C Fy = 50 KSI.

2

- ALL ANCHOR BOLTS SHALL CONFORM TO ASTM F 1554, GRADE 55..
- BE ASTM A325X. HIGH STRENGTH BOLTS FOR STEEL-TO-STEEL CONNECTIONS SHALL
- ALL NUTS SHALL BE ASTM A 563, UNLESS NOTED OTHERWISE
- ALL WASHERS SHALL BE ASTM F 436, UNLESS NOTED OTHERWISE.

SPECIAL INSPECTION SCHEDUL FSTABIISHEN DER 2015 IBC SECTION 110 & CHAPTER A. ALL REINFORCING STEEL SHALL BE DEFORMED STEEL BARS CONFORMING TO ASTM A 615 - GRADE 60, EXCEPT AS NOTED. LENGTHS ARE BASED ON CLASS "B", CASE 1 SPLICES (MAX OF 50% OF BARS SPLICED AT ONE LOCATION. B. LAP ALL REINFORCING BARS AS NOTED ON THE DRAWINGS. DEFORMED BAR LAP SPLICES SHALL CONFORM TO THE FOLLOWING, UNLESS OTHERWISE SHOWN. SCHEDULE OF MINIMUM f'c = 5000 PSITOP BARS OTHER BARS LAP SPLICE LENGTHS

BAR SIZE

#10

NOTES:

7

AMERICAN SOCIETY FOR TESTING MATERIALS AMERICAN WELDING SOCIETY

CENTERLINE CLEAR CONCENTRIC

DEMOLISH

DEMO

BOTTOM OF BASEPLATE

ABBREVIATIONS

- TOP BARS ARE DEFINED AS ANY HORIZONTAL BAR PLACED SUCH THAT MORE THAN 12" OF FRESH CONCRETE IS CAST IN THE MEMBER BELOW THE BAR IN ANY SINGLE POUR.
- STAGGER ALL LAP SPLICES IN ADJACENT BARS BY ONE LAP LENGTH +1'-0" MINIMUM.
- NO MORE THAN 50% OF THE REINFORCING BARS IN ANY LAYER SHALL BE SPLICED AT ONE LOCATION.
- " (MSP). REINFORCING SHALL BE SUPPORTED AS SPECIFIED BY THE PROJECT SPECIFICATIONS AND THE CRSI "MANUAL OF STANDARD PRACTICE," REINFORCING STEEL SHALL BE DETAILED IN ACCORDANCE WITH "ACI DETAILING MANUAL," ACI SP-66. ن
- ALL HORIZONTAL REINFORCEMENT AT DISCONTINUITIES AND AND CORNERS SHALL END WITH STANDARD 90' HOOKS IN ACCORDANCE WITH ACI SP-66, UNLESS SHOWN OTHERWISE.

Ö.

- MINIMUM COMPRESSIVE STRENGTH AT 28 DAYS CAST-IN-PLACE CONCRETE
 - 5000 PSI CAST-IN-PLACE CONCRETE FOUNDATIONS
- CONSTRUCTION JOINTS SHALL BE PROVIDED ONLY AS NOTED ON THE DRAWINGS AS SPECIFICALLY PERMITTED BY THE ENGINEER. ALL EXPOSED CORNERS SHALL BE CHAMFERED 3/4 IN.
- CONCRETE MIXTURES SHALL CONFORM TO THE MOST RESTRICTIVE REQUIREMENTS OF ACI 318-14 FOR EXPOSURE CLASSES F3, SO, WO & C2.

WELDING

- ALL WELDING SHALL BE PERFORMED BY WELDERS QUALIFIED FOR THE WELD AND POSITION SHOWN IN ACCORDANCE WITH AWS AND HAVING CURRENT CERTIFICATION FROM WABO.
 - ALL WELDS SHALL BE PERFORMED WITH PROCEDURES PREQUALIFIED OR QUALIFIED IN ACCORDANCE WITH AWS D1.1 AND D1.4. 2
- THE WELDS SHOWN ARE FOR THE FINAL CONNECTIONS, FIELD WELD SYMBOLS ARE SHOWN WHERE FIELD WELDS ARE REQUIRED BY THE STRUCTURAL DESIGN. THE CONTRACTOR IS RESPONSIBLE FOR DETERMINING IF A WELD SHOULD BE SHOP— OR FIELD—WELDED IN ORDER TO FACILITATE THE STRUCTURAL STEEL ERECTION. 3
 - WELDING ELECTRODES SHALL BE 70 KSI STRENGTH AND SHALL BE "LOW-HYDROGEN" ELECTRODES.

DATE

NO.

ESTABLISHED PEF	ESTABLISHED PER 2015 IBC SECTION 110 & CHAPTER 17	ION 110 & CHAP	TER 17
ITEM	CONTINUOUS	PERIODIC INSPECTION	COMMENTS
GRADING, EXCAVATION & FILL		×	
FINAL FOUNDATION PREPARATION		×	
DRILLED SHAFT INSTALLATION	×		BY GEOTECHNICAL ENGINEER OF RECORD
CONCRETE			
REINFORCING PLACEMENT		×	
REINFORCING WELDING		×	
ANCHOR BOLTS & INSERTS		×	
PREPARATION OF TEST SPECIMENS	×		
CONCRETE PLACEMENT	×		
CURING		×	
STRUCTURAL STEEL			
FABRICATION & ERECTION		×	
SINGLE PASS FILLET WELDS ≤ 5/16"		×	REF. NOTE 5
FILLET WELDS > 5/16"	×		REF. NOTE 5
PARTIAL/COMPLETE PENETRATION WELD	×		REF. NOTE 6

INTERNATIONAL BUILDING CODE INCH

Z BC

THREAD

NATIONAL PIPE 1 NEAR SIDE

NPT NS

MAXIMUM MINIMUM MISCELLANEOUS

MAX

PROPERTY LINE PLACES POINT OF CONNECTION

RADIUS REFERENCE

SHORT SLOTTED HOLE

SIMILAR SHORT S

STIFFENER SYMMETRICAL

TOP OF TO TOP OF THICK(NESS) THROUGH

HORIZONTAL HIGH POINT HOLLOW STRUCTURAL SECTION

HORIZ HP HSS

FOUNDATION FAR SIDE FEET

ECCENTRIC EACH FACE ELEVATION EXISTING

SPECIAL INSPECTION SCHEDULE NOTES

- 1. THE ITEMS CHECKED WITH AN "X" SHALL BE INSPECTED IN ACCORDANCE WITH IBC CHAPTER 17 BY A CERTIFIED INSPECTOR FROM AN ESTABLISHED TESTING AGENCY. FOR MATERIAL SAMPLING AND TESTING REQUIREMENTS, REFER TO PROJECT SPECIFICATIONS, THE STRUCTURAL NOTES AND THE NOTES BELOW. THE TESTING AGENCY SHALL SEND COPIES OF ALL STRUCTURAL TESTING AND INSPECTION REPORTS DIRECTLY TO THE ENGINEER. ANY MATERIALS WHICH FAIL TO MEET THE PROJECT SPECIFICATIONS SHALL IMMEDIATELY BE BROUGHT TO THE ATTENTION OF THE ENGINEER. SPECIAL INSPECTION TESTING REQUIREMENTS APPLY EQUALLY TO ALL BIDDER DESIGNED COMPONENTS.
- SPECIAL INSPECTION IS NOT REQUIRED FOR WORK PERFORMED ON THE PREMISES OF AN APPROVED FABRICATOR PER IBC SECTION 1704.2.5.2.
- CONTINUOUS SPECIAL INSPECTION MEANS THAT THE SPECIAL INSPECTOR IS ON THE SITE AT ALL TIMES OBSERVING THE WORK REQUIRING SPECIAL INSPECTION (BC 1702). PERIODIC SPECIAL INSPECTION MEANS THAT THE SPECIAL INSPECTIOR IS ON SITE AT TIME INTERVALS NECESSARY TO CONFIRM THAT ALL WORK REQUIRING SPECIAL INSPECTION IS IN COMPLIANCE. 3


MICROPILES. MICROPILE LENGTHS SHALL BE ESTABLISHED AND PILE CAPACITIES VERIFIED BY THE CONTRACTOR IN ACCORDANCE WITH THE PROVIECT SPECIFICATIONS. THE CONTRACTOR SHALL PROVIDE CALCULATIONS FOR THE DESIGN OF THE PILES AND THE PILE CONNECTIONS TO THE STRUCTURE. CALCULATIONS SHALL BEAR THE STAMP AND SIGNATURE OF THE WASHINGTON STATE PROFESSIONAL ENGINEER WHO IS RESPONSIBLE FOR THE DESIGN. PILE DESIGN LOADS ARE INDICATED ON THE DRAWINGS. PILE CONNECTIONS SHALL BE ABCQUAFE TO RESIGN THE PILE TENSION AND COMPRESSION DESIGN LOADS INDICATED ON THE DRAWINGS. SEE PROJECT SPECIFICATIONS FOR ADDITIONAL INFORMATION.


- INSPECTION REQUIREMENTS FOR SYSTEMS DESIGNED BY OTHERS SHALL BE DEFINED BY THE REGISTERED DESIGN PROFESSIONAL RESPONSIBLE FOR THEIR DESIGN.
- ALL WELDS SHALL BE VISUALLY INSPECTED.
- COMPLETE PENETRATION WELDS SHALL BE TESTED ULTRASONICALLY BY USING ANOTHER APPROVED METHOD. AP R 9
- TPU WILL EMPLOY AND PAY FOR SPECIAL INSPECTION & TESTING SERVICES TO ENSURE COMPLIANCE WITH THE REQUIREMENTS OF T CONTRACT DOCUMENTS. SEE SPECIFICATION FOR ADDITIONAL INFORMATION.

SEATTLE INON AND METALS	701 S ORCHARD ST, SEATTLE WA 98108	TROMMEL SCREEN FRAME	STRUCTURAL NOTES
	701 S ORCH,	TROM	ST


SHT DESIGN: KCP CHECKED: SMS DRAWING NO. SHEET NO.

5

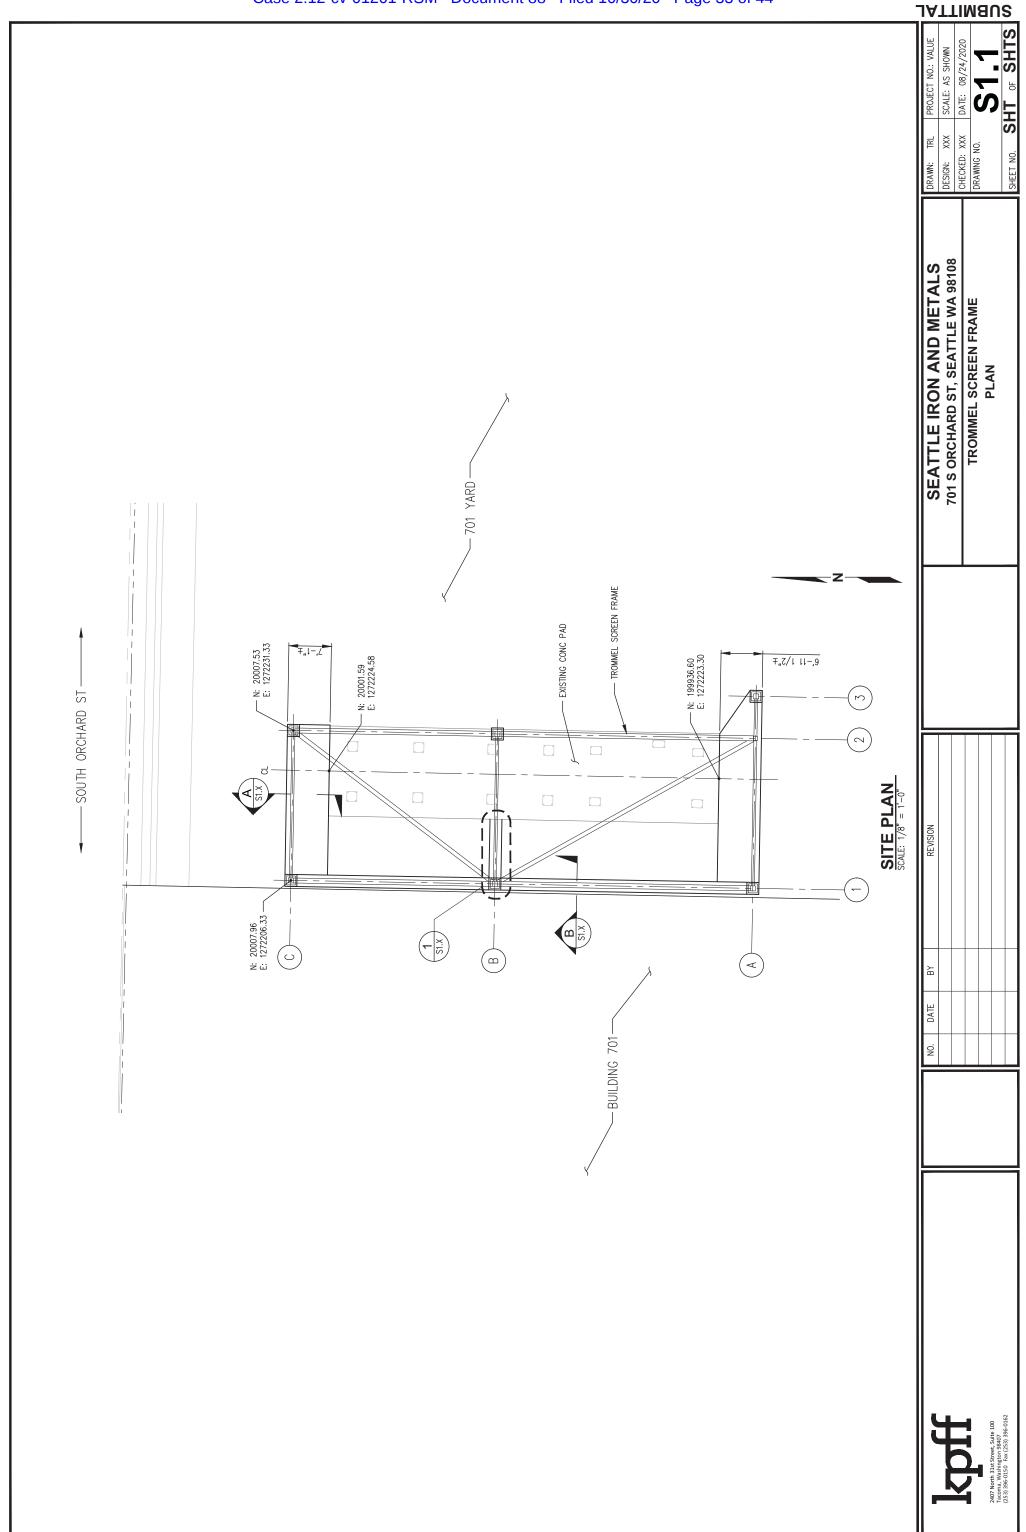


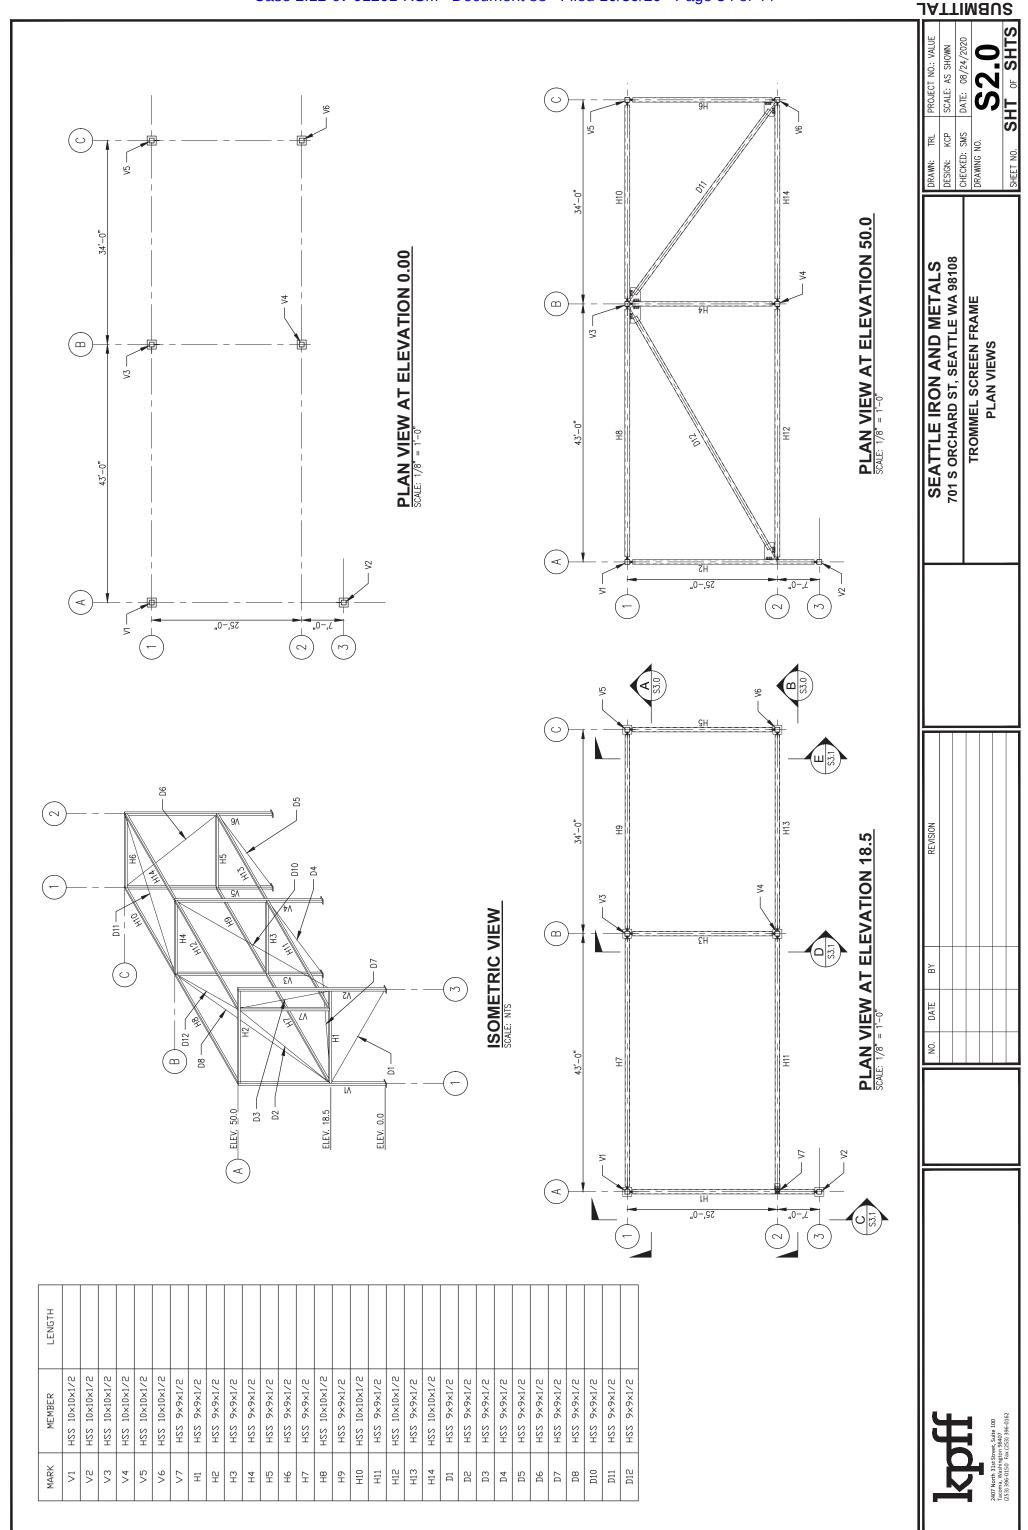



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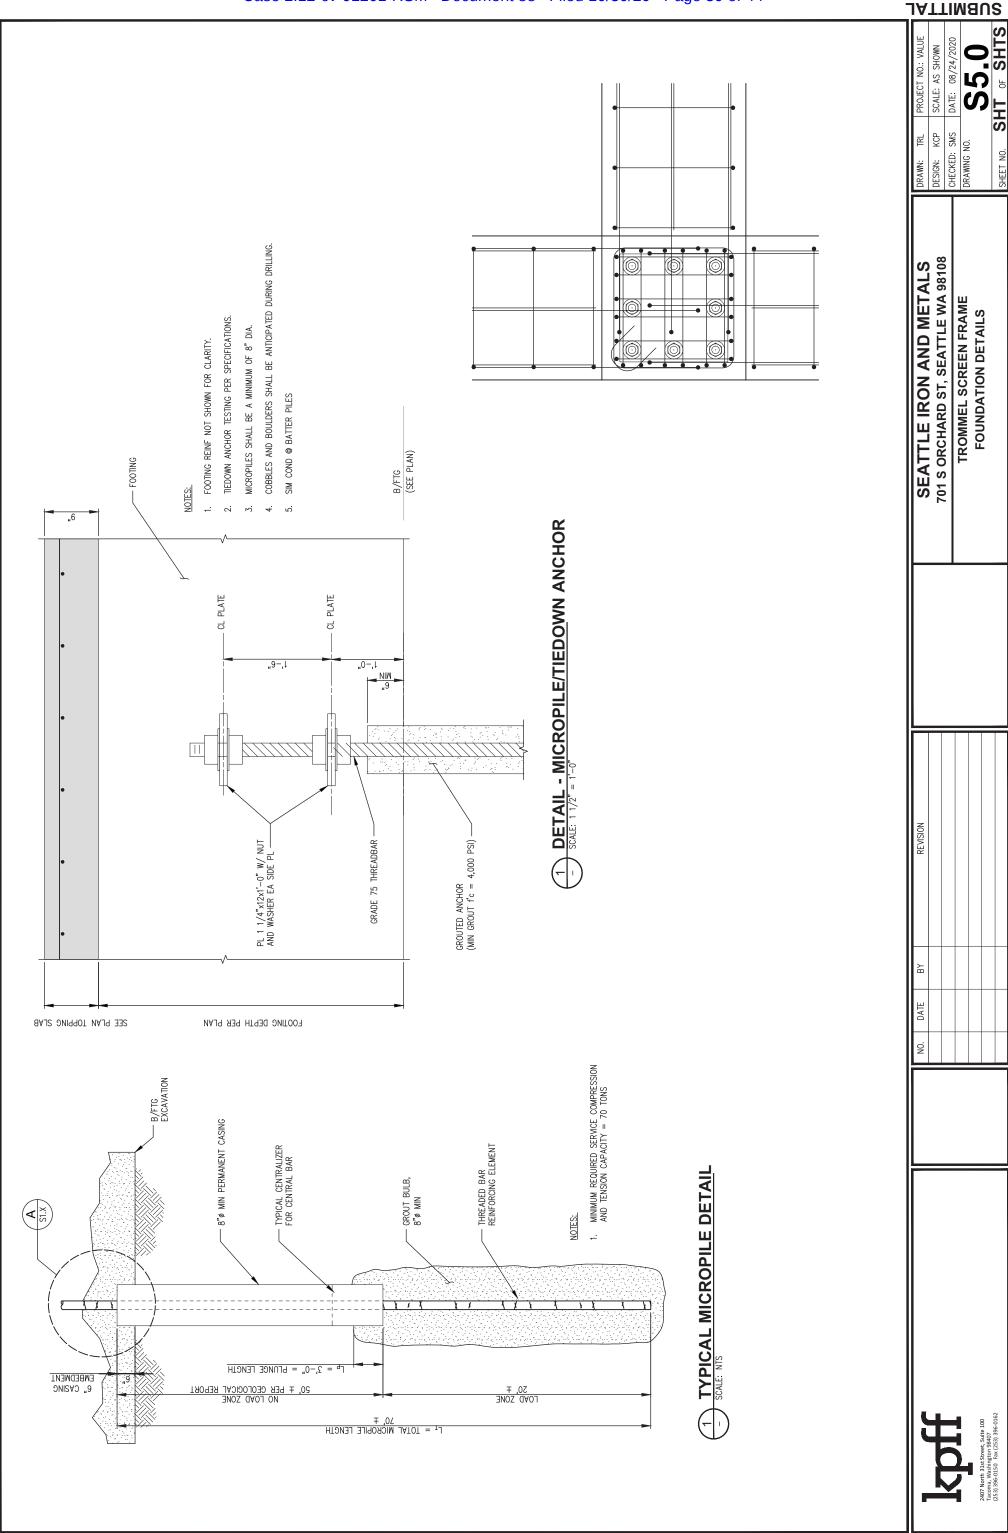


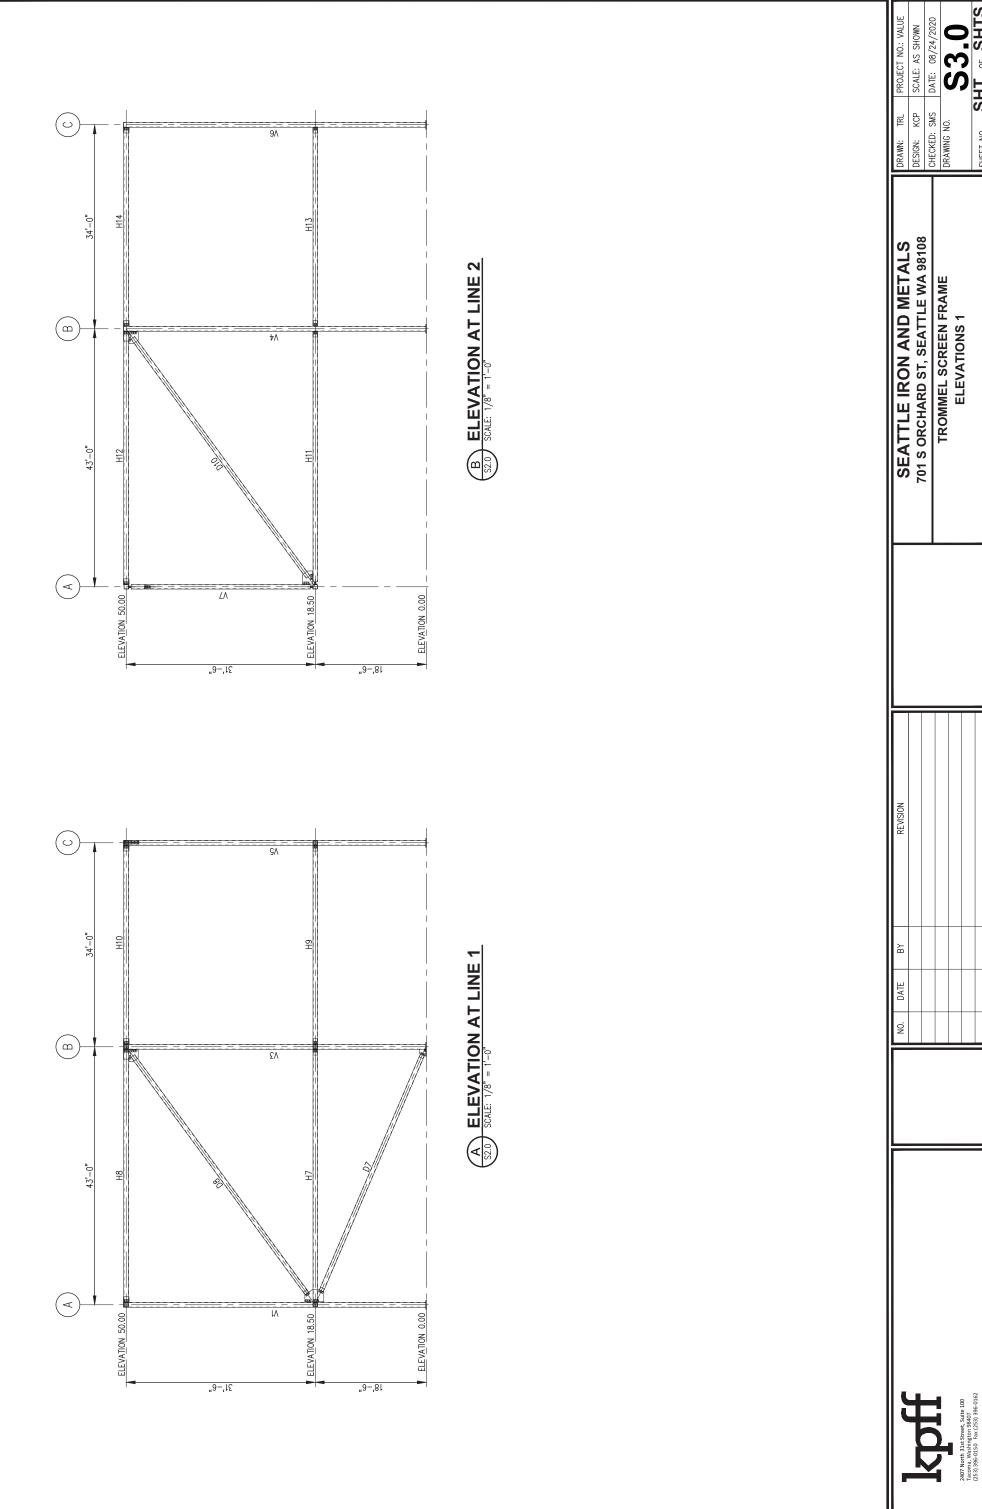
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Attachment D

RESTRICTED & APPROVED TRUCK TRAFFIC ROUTES **SEATTLE IRON & METALS CORP.**

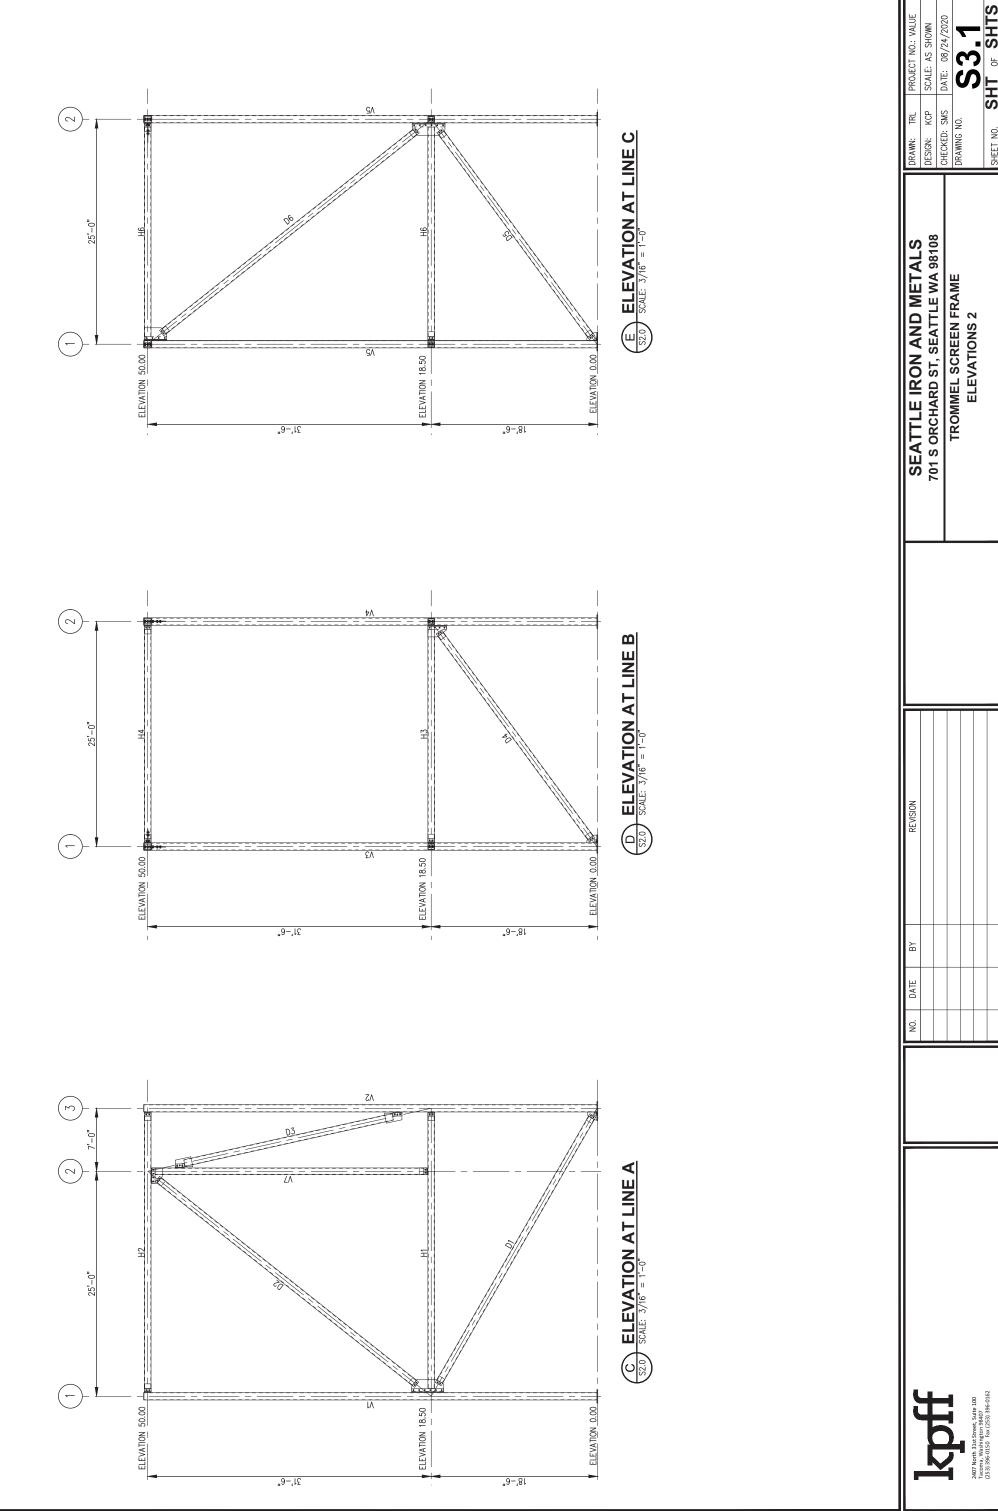

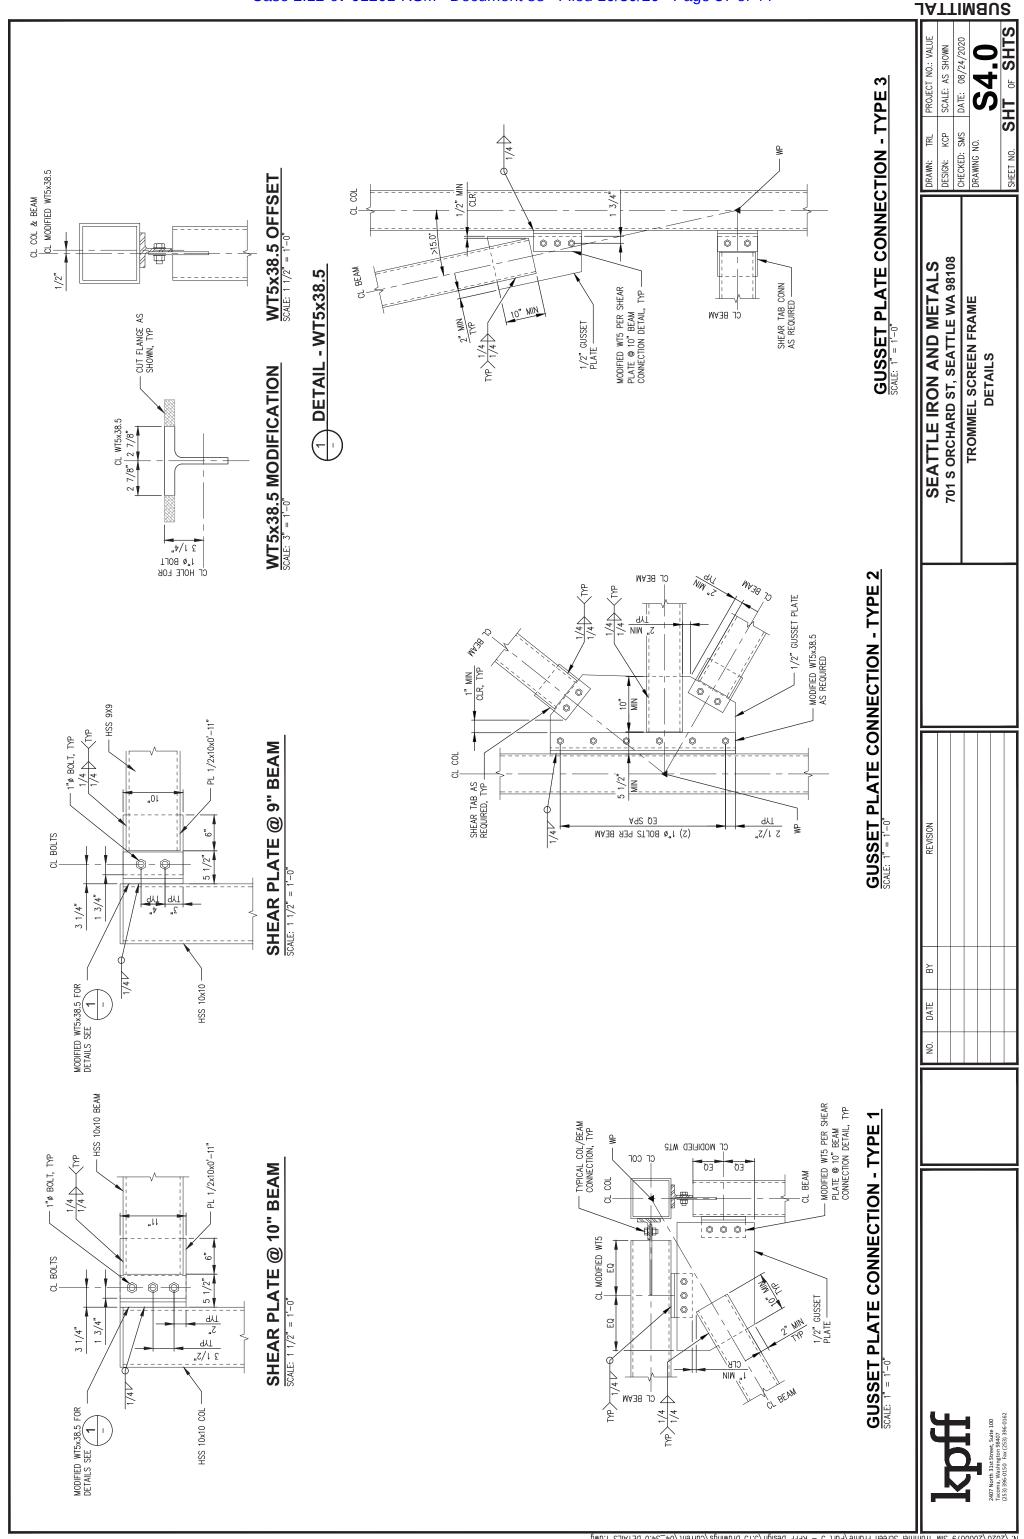Seattle Iron & Metals

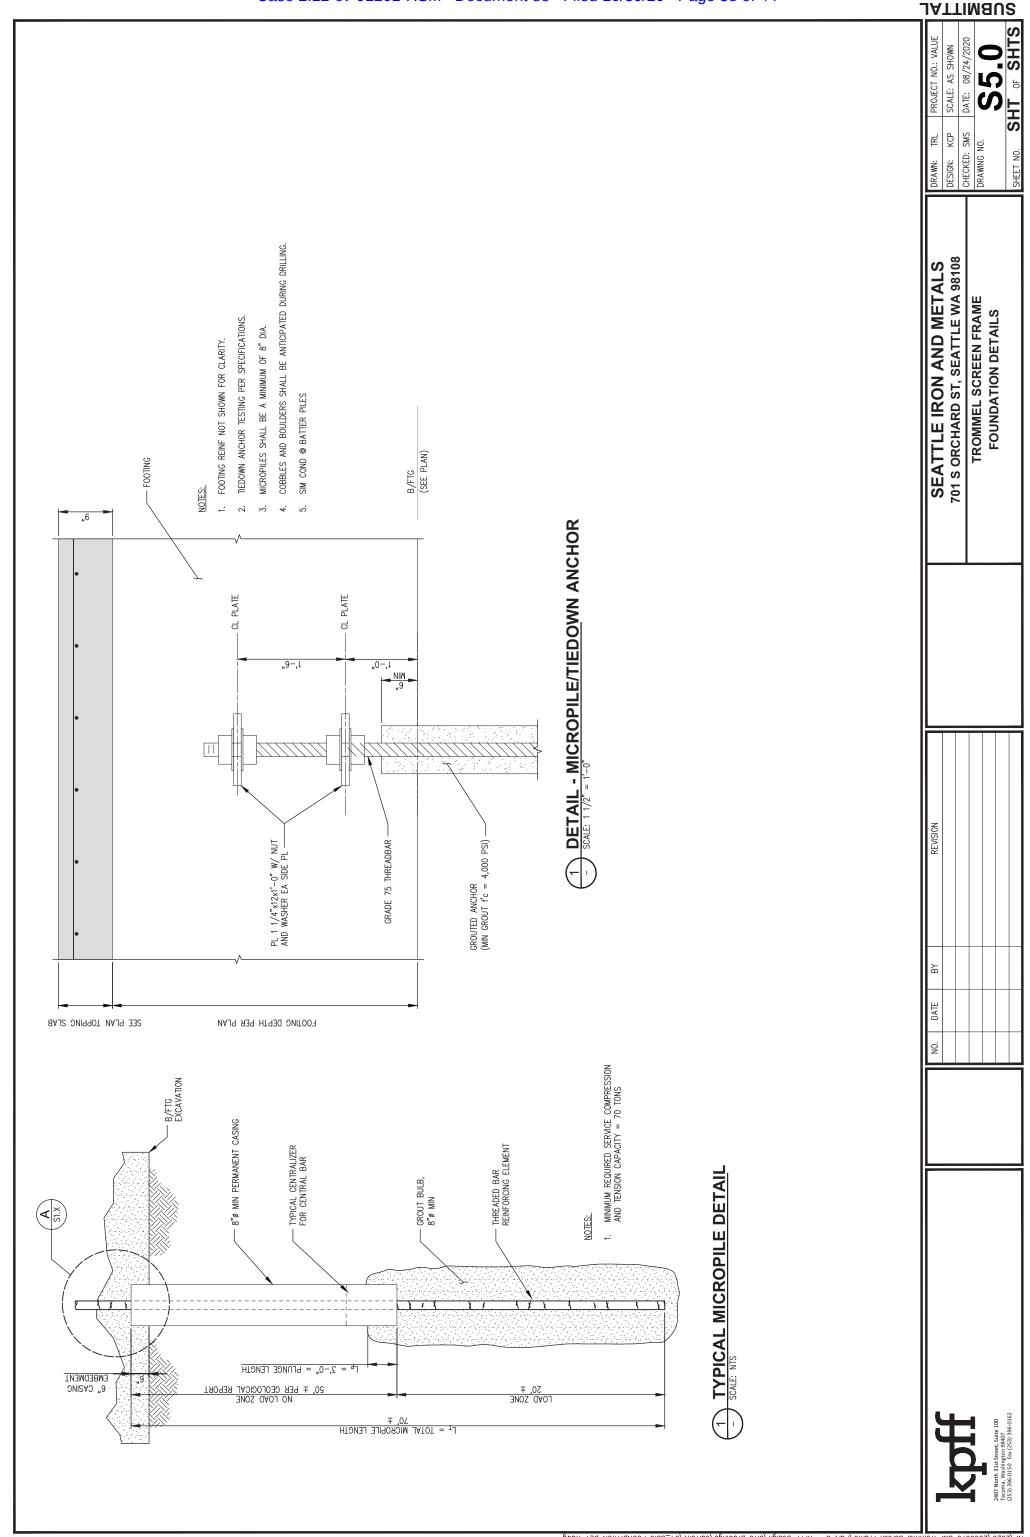Restricted Routes (AVOID driving here) // Approved Routes

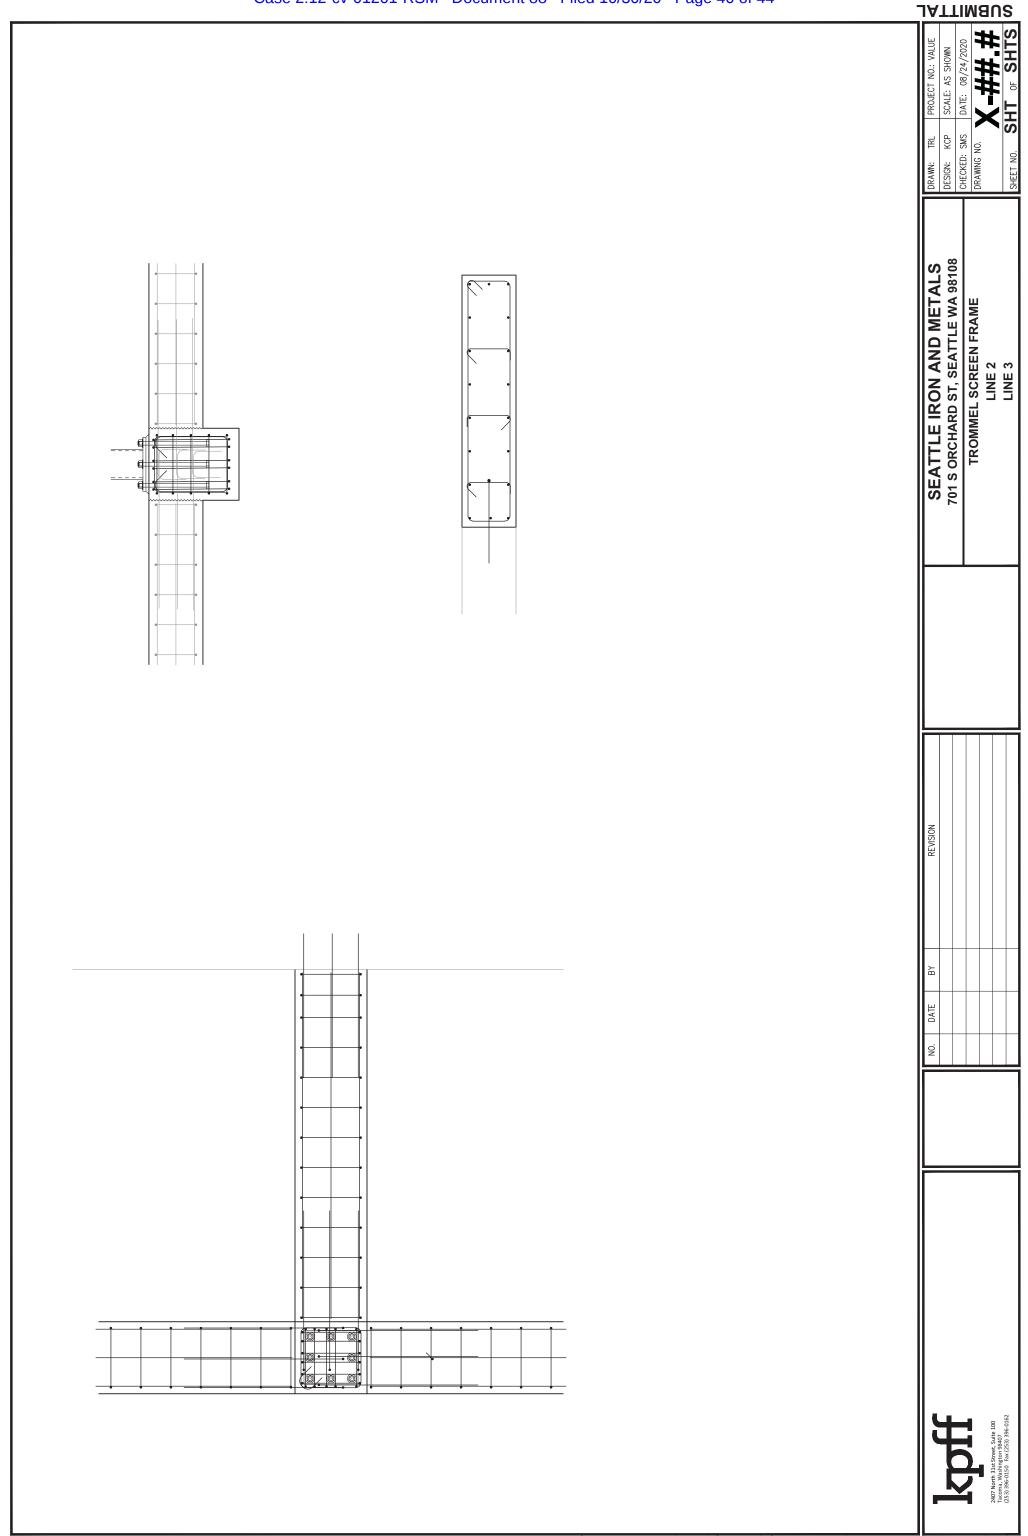



Map: Google Earth Date: Jan 15, 2019 Base

Seattle WA, 98108 South Myrtle Street Seattle Iron & Metals Corp.



Attachment E

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105 South Main Street, #235 Seattle, Washington 98104 206.332.9900 seattleparksfoundation.org

Connecting Seattle through Public Space

8/12/20

To Whom it may Concern:

This letter is intended to provide assurance that I have received the Consent Decree between Puget Soundkeeper Alliance and Seattle Iron and Metals and that I am authorized on behalf of Seattle Parks Foundation to make the following binding commitments:

- 1. I understand that Seattle Parks Foundation will receive funds from Seattle Iron and Metals as specified in the Consent Decree.
- 2. Seattle Parks Foundation will use these funds for advancing the design for water quality improvements at Gateway Park N.
- 3. Seattle Parks Foundation will not use any money it receives under the Consent Decree for lobbying purposes.

Seattle Parks Foundation is the fiscal sponsor for the Georgetown Open Space Committee who is leading a business-community-government-NGO collaborative addressing water quality by developing community driven green infrastructure in the street right-of-way at the end of 8th Ave S. Community-based organizations are leading the design, permitting and installation of green stormwater infrastructure and are providing educational and job opportunities that improve the environmental wellbeing and promote public health education for people who live, work and play nearby.

The project has been designed to 30% and will use additional funds for additional design development that ties the shoreline restoration with the upland area and knits together the parcels owned by different agencies with engineering level specificity. This level of design, which includes review by public sector entities brings the project closer to "shovel-readiness." The overall project improves public access to the River, improves shoreline habitat, and reduces polluted run off from entering the River.

Seattle Parks Foundation (Tax ID 91-1998597) provides 501(c)(3) tax-exempt status and a suite of accounting, insurance, fundraising, and communications services to community groups that are leading park and public space projects across the city. We manage restricted and general-purpose funds for donors who want to make long-term investments in Seattle's parks and public spaces and support large-scale community park planning and development such as Gateway Park N. in Georgetown. We are committed to sound fiscal management and as a nonprofit organization are audited annually.

Please do not hesitate to contact me with questions or for additional information.

Sincerely,

Thatcher Bailey, President and CEO

Matcher Bailey